
ASHEBORO BY-PASS ASHEBORO, NORTH CAROLINA

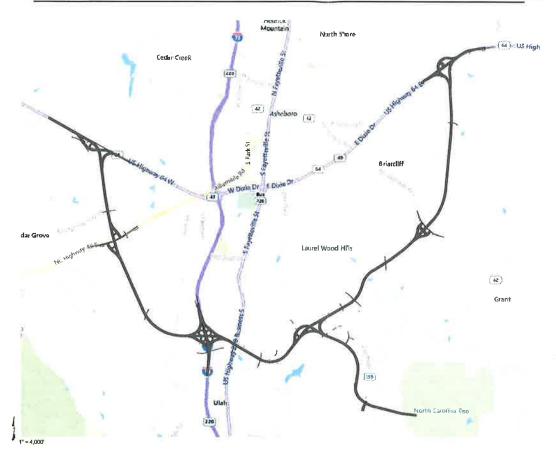

| DRA | WING INDEX: |
|--------|-------------------|
| L-0.0 | COVER SHEET |
| L-0,1 | SHEET LAYOUT PLAN |
| L-1.7 | LS1 - SHEET 7 |
| L-1,13 | LS1 - SHEET 13 |
| L-1.18 | LS2 - SHEET 18 |
| L-1.19 | LS2 - SHEET 19 |
| L-1.22 | LS2 - SHEET 22 |
| L-1.70 | LS2 - SHEET 70 |
| L-1,23 | LS2 - SHEET 23 |
| L-1,25 | LS2 - SHEET 25 |
| L-1.27 | LS2 - SHEET 27 |
| L-1.28 | LS2 - SHEET 28 |
| L-1,29 | LS2 - SHEET 29 |
| L-1,30 | LS2 - SHEET 30 |
| L-1,81 | LS2 - SHEET 81 |
| L-1.32 | LS2 - SHEET 32 |
| L-1.33 | LS2 - SHEET 33 |
| L-1.40 | LS3 - SHEET 40 |
| L-1.41 | LS3 - SHEET 41 |
| L-1.43 | LS3 - SHEET 43 |
| L-1.44 | LS3 - SHEET 44 |
| L-1.48 | LS3 - SHEET 48 |
| L-1.49 | LS3 - SHEET 49 |
| L-1.53 | LS3 - SHEET 53 |
| | TOO THEF SHOTEON |

L-2.0 ZOO - TREE PROTECTION & EROSION CONTROL L-2.1 ZOO - LANDSCAPE PLAN L-3.0 NCDOT DETAILS



| TOTAL PROJECT | QTY | UNIT | ITEM |
|---------------|--------|------|--|
| | 266884 | SF | PINE STRAW MULCH |
| | 1854 | CY | HARDWOOD MULCH |
| | 443544 | SF | GRUBBING (REMOVAL OF TURF AND WEEDS) |
| | 98878 | SY | POST-EMERGENT HERBICIDE |
| | 98878 | SY | PRE-EMERGENT HERBICIDE |
| | 400 | MG | WATERING (INITIAL PLANTING & FIRST YEAR ESTABLISHMENT) |
| | 12 | EA | MONTHLY MAINTENANCE/ESTABLISHMENT OVER 2-YEARS |
| | 3705 | CY | ORGANIC COMPOST FOR SEED & PLUG AREAS |

| TREES | OTY | BOTANICAL NAME | COMMON NAME | MIN, INSTALLED SIZE | ROOT | TYPE | | REMARKS |
|---------|------------|--|--|--------------------------------|---|-----------------|----------|--|
| | - | WATER TO THE PARTY OF THE PARTY | | No. of Lot, Labor, Bellin, St. | THE RESERVE OF THE PERSON NAMED IN | | | (PER LOS AND DUDING ATTENDED |
| AGA | 50 | AMELANCHIER X GRANDIFLORA 'AUTUMN BRILLIANCE' | AUTUMN BRILLIANCE APPLE SERVICEBERRY | 1,5" CAL., 6-8" HT. MIN. | B&B OR CONTAINER | UNDERSTORY TREE | | FULL & HEAVY, UNIFORM CANOPYY |
| cc | 20 | CERCIS CANADENSIS | EASTERN REDBUD MULTI-STEM | 1,5" CAL., 6-8" HT. MIN. | B&B OR CONTAINER | UNDERSTORY TREE | | FULL & HEAVY, UNIFORM CANOPY |
| CCF | 14 | CERCIS CANADENSIS "FOREST PANSY" | FOREST PANSY REDBUD | 1,5" CAL., 6-8" HT. MIN. | B&B OR CONTAINER | UNDERSTORY TREE | | FULL & HEAVY, UNIFORM CANOPY |
| CCM | 95 | CERCIS CANADENSIS "MERLOT" | MERLOT REDBUD | 1,5" CAL,, 6-8" HT, MIN. | B&B OR CONTAINER | UNDERSTORY TREE | | FULL & HEAVY, UNIFORM CANOPY |
| - | • | CONTRACTOR OF THE PERSON OF TH | | CHARLES MINE | AND DESCRIPTION OF THE PERSON NAMED IN | Contract on the | | |
| • | 90 | | NAME OF TAXABLE PARTY. | CELLIL MAN | OAD COLUMN | | | |
| €T. | 18 | GLEDITSIA TRIACANTHOS F. INERMIS | THORNLESS HONEY LOCUST | 3" CAL., 12' HT, MIN. | B&B OR CONTAINER | SPECIMEN | | FULL AND HEAVY, UNIFORM CANOPY |
| 0 | 210 | ILEX OPACA | AMERICAN HOLLY | 6 -8 HT | B&B OR CONTAINER | EVERGREEN | | FULL & DENSE |
| IV | 290 | JUNIPERUS VIRGINIANA | EASTERN RED CEDAR | 6'-8' HT. | B&B OR CONTAINER | EVERGREEN | | FULL & DENSE |
| .s | 11 | LIQUIDAMBAR STYRACIFLUA | AMERICAN SWEET GUM | 1.5" CAL., 6-8" HT. MIN. | B&B OR CONTAINER | SHADE TREE | | FULL & HEAVY, SINGLE STRAIGHT LEADE |
| T | 6 | LIRIODENDRON TULIPIFERA | TULIP TREE | 1,5" CAL, 6-8" HT. MIN. | B&B OR CONTAINER | SHADE TREE | | FULL & HEAVY, SINGLE STRAIGHT LEADER |
| //G | 32 | MAGNOLIA GRANDIFLORA | SOUTHERN MAGNOLIA | 6 -8 HT | B&B OR CONTAINER | EVERGREEN | | FULL & DENSE |
| //GL | 19 | MAGNOLIA GRANDIFLORA "LITTLE GEM" | LITTLE GEM SOUTHERN MAGNOLIA | 6'-8' HT, | B&B OR CONTAINER | EVERGREEN | | FULL & DENSE |
| ٧V | -21 | MAGNOLIA VIRGINIANA | SWEETBAY MAGNOLIA | 6'-8" HT. | B&B OR CONTAINER | UNDERSTORY TREE | | FULL & DENSE |
| | - | | THE COLUMN TWO IS NOT | | CONTRACTOR OF THE PARTY OF THE | | | CONTRACTOR OF THE PROPERTY OF |
| NO. | | MINISTRAL PRINCIPLE STATE OF THE PRINCIPLE ST | WALES HAVE BEEN AND ASSESSMENT | CECL SELLO | SERVICE CONTRACTOR | | | Communication of the last of t |
| r T | 524 | PINUS TAEDA | LOBLOLLY PINE | 6'-8" HT | CONTAINER | EVERGREEN | | FULL & DENSE |
| o | 43 | PLATANUS OCCIDENTALIS | AMERICAN SYCAMORE | 1.5" CAL., 6-8" HT. MIN. | B&B OR CONTAINER | SHADE TREE | | FULL & HEAVY, SINGLE STRAIGHT LEADE |
| 02 | 6 | PLATANUS OCCIDENTALIS | AMERICAN SYCAMORE | 3" CAL., 12" MIN. | B&B OR CONTAINER | SHADE TREE | | FULL & HEAVY, SINGLE STRAIGHT LEADE |
| | • | CONTRACTOR OF THE PARTY OF THE | | SECURITION. | STORY DESIGNATION | GHADDISON | | THE RESIDENCE OF THE PARTY OF T |
| | • | COLUMN SAME OF | No. of Concession, Name of Street, or other party of the Concession, Name of Street, or other pa | Committee and other lands | OMBORIOGENIA DE | CHILLIPS TO | | CALL THE AND THE PARTY OF THE P |
| | | CONTRACTOR OF THE PARTY OF THE | CONTRACTOR DE LA CONTRA | | SANDEROWANES | GM89998MB | | NUMBER OF STREET |
| /A | 15 | VITEX AGNUS-CASTUS | CHASTE TREE | 6' HT. | CONTAINER | SPECIMEN | | MULTI-STEM, FULL BRANCHING |
| | | 1 | * | | | | | |
| SHRUBS | QTY | BOTANICAL NAME | COMMON NAME | MIN. INSTALLED SIZE | ROOT | REMARKS | | REMARKS |
| VIC . | 28 | MYRICA CERIFERA | WAX MYRTLE | 36" HT /SPRD | CONTAINER | FULL AND DENSE | | |
| BRASSES | Тоту | BOTANICAL NAME | COMMON NAME | MIN. INSTALLED SIZE | ROOT | 1 | SPACING | |
| E | 1,766 | JUNCUS EFFUSUS | SOFT RUSH | 2" PLUG | CONTAINER | | 18" o.c. | |
| ICW | 211,548 SF | MUHLENBERGIA CAPILLARIS 'WHITE CLOUD' | WHITE CLOUD MUHLY GRASS | SEED | CONTAINEN | | 10 0,0, | |
| IT. | 10,760 | NASSELLA TENUISSIMA | MEXICAN FEATHER GRASS | 4" POT | CONTAINER | | 24" o.c. | |
| vs | 232,599 SF | PANICUM VIRGATUM 'SHENANDOAH' | SHENANDOAH SWITCH GRASS | SEED | GONTAINEN | | 24 0,0, | |
| VC | 461 | PANICUM VIRGATUM 'CLOUD NINE' | CLOUD NINE SWITCH GRASS | 1 GAL | CONTAINER | | 24" p.c. | FULL AND DENSE |
| VR | 39,868 | PANICUM VIRGATUM 'RR1' TM | RUBY RIBBONS SWITCH GRASS | 2" PLUG | CONTAINER | | 12" o.c. | DELAGE |
| S | 164 | SCHIZACHYRIUM SCOPARIUM | LITTLE BLUESTEM | 1 GAL | CONTAINER | | 24" o.c. | FULL & DENSE |
| HP | 10,154 | SPOROBOLUS HETEROLEPIS | PRAIRIE DROPSEED | 2" PLUG | CONTAINER | | 18" o.c. | JOEE W DENGE |
| HS | 19.075 SF | SPOROBOLUS HETEROLEPIS | PRAIRIE DROPSEED | SEED | CONTAINER | | 10 0.0. | |

GENERAL PLANTING NOTES:

| | ten ma continue | | | |
|--|-----------------|------|------|--|
| | | | | |
| | | | | |
| | | | | |
| | | | | |

- IDENTIFY ANY SUBSURFACE UTILITIES PRIOR TO COMMENCING WORK.
 ALL PLANT MATERIALS TO COMPLY WITH AMERICAN STANDARD FOR NLRSERY STOCK ANSI, 260.
 SUBSTITUTIONS OF PLANT MATERIALS SPECIFIED CAN ONLY OCCUR WITH PRIOR APPROVAL BY LANDSCAPE ARCHITECT AND/OR ENGINEER.
 CONTRACTOR TO PROTECT EXISTING DRAINAGE STRUCTURES THROUGHOUT CONSTRUCTION, ANY DAMAGE TO DRAINAGE STRUCTURES SHALL BE
 REPAIRED IN KIND BY CONTRACTOR AT NO ADDITIONAL COST TO THE OWNER.
 CONTRACTOR SHALL LOCATE ALL UTILITIES PRIOR TO CONSTRUCTION, ALL UTILITIES SHALL BE PROTECTED THROUGHOUT CONSTRUCTION AND
 ANY DAMAGE THAT MAY OCCUR SHALL BE REPAIRED IN KIND BY THE CONTRACTOR WITH NO ADDITIONAL COST TO THE OWNER.
 INSTALL ALL PLANT MATERIALS AS DEFINED BY DETAILS AND SPECIFICATIONS...
 ALL TREES TO BE INISTALLED BEFORE MARCH 15 OR AFTER OCTOBER 15,
 ALL PLANTED AREAS TO BE MULCHED AS INDICATED ON THE PLANDS PER SPECIFICATIONS.
 ALL PLANTED AREAS TO BE MULCHED AS INDICATED ON THE PLANDS PER SPECIFICATIONS.
 ALL PLANTED AREAS TO BE MULCHED AS INDICATED ON THE PLANDS PER SPECIFICATIONS.
 ALL TREES SHALL BE IN A UNIFORM BED OF MULCH WITH THE BED EDGE NO LESS THAN 3' FROM THE TRUNK OF THE TREE, KEEP MULCH 4" AWAY FROM TRUNK OF TREE.
- 10. CONTRACTOR TO REPAIR ANY DAMAGED TURF AREAS DUE TO CONSTRUCTION ACTIVITIES.
- 10. CONTRACTOR TO REPAIR UNDISTURBED TURE AREAS DUE TO CONSTINUTION ACTIVITIES.
 11. CONTRACTOR TO REPAIR UNDISTURBED TURE AREAS AT DIRECTION OF ENGINEER OR LANDSCAPE ARCHITECT, TO BE PAID PER TURF UNIT PRICE.
 12. CONTRACTOR TO WARRANTY PLANT MATERIALS FOR A TWO YEAR PERIOD FOLLOWING SUBSTANTIAL COMPLETION.
 13. CONTRACTOR TO ESTABLISH AND MAINTAIN PLANT MATERIAL PER SPECIFICATIONS.
 14. AREAS DAMAGED BY ACTIVITIES OF CONTRACTOR SHALL BE RE-ESTABLISHED TO PRE-DISTURBANCE CONDITION AT NO ADDITIONAL COST TO THE

- CONTRACT OF TO ESTABLISH AND MAINTAIN PLANT MATERIAL PER SPECIFICATIONS.
 AREAS DAMAGED BY ACTIVITIES OF CONTRACTOR SHALL BE RE-ESTABLISHED TO PRE-DISTURBANCE CONDITION AT NO ADDITIONAL COST TO THE OWNER.
 CONTRACTOR SHALL INSURE THAT ALL PLANT MATERIAL IS FREE OF FIRE ANTS PRIOR TO INSTALLATION.
 LOCATIONS OF PLANTS AND PLANT BEDS TO BE FLAGGED BY CONTRACTOR AND VERIFIED IN THE FIELD BY LANDSCAPE ARCHITECT, ENGINEER AND/OR OWNER PRIOR TO INSTALLATION.
 CONTRACTOR TO IDENTIFY STAGING AREAS, LANDSCAPE ARCHITECT/ENGINEER AND/OR OWNER TO APPROVE LOCATIONS PRIOR TO CONSTRUCTION.
 AREAS DISTURBED THAT ARE NOT NOTED FOR PLANT BEDS ARE TO BE SEEDED AND STRAWED PER SPECIFICATIONS.
 PLANT MATERIAL NOT NOTED FOR REMOVAL SHALL BE PROTECTED THROUGHOUT CONSTRUCTION.
 USE HERBICIDES, PESTICIDES, AND FERTILIZER IN A MANNIER CONSISTENT WITH THE FEDERAL INSECTICIDE, FUNGICIDE, AND RODENTICIDE ACT, NODOT STANDARDS AND SPECIFICATIONS.
 ALL AREAS NOTED FOR GRUBBING TO BE FINE GRADED TO A SIMOOTH AND UNIFORM CONDITION WITH NO BUMPS OR RILLS. ALL STICKS, ROCKS OVER 3°, AND OTHER DEBRIS SHALL BE REMOVED PRIOR TO RIMAL ACCEPTANCE OF SOIL CONDITION.
 ALL AREAS IDENTIFIED TO HAVE HARDWOOD MUCHED ARE TO BE GRUBBED.
 ALL AREAS IDENTIFIED TO THE ARROWOOD PRIOR TO RIMAL ACCEPTANCE OF SOIL CONDITION.
 ALL ARRAS IDENTIFIED TO THE ARROWOOD STANDARDS FOR FINAL CONDITION OF CLEARED AND GRUBBED AREAS PRIOR TO PLANT BY THE TREES WITH DAMAGED OR DEFORMED TAP ROOT.
 PRIOR TO PLANTING PINE TREES, CONTRACTOR IS TO INSPECT TAP ROOT OF EACH TREE. DO NOT PLANT PINE TREES WITH DAMAGED OR DEFORMED TAP ROOT.
 APPLY ALL TRAFFIC CONTROL MEASURES PER NCDOT STANDARDS AND AS DIRECTED BY NCDOT ENGINEER.
- DEFORMED TAY ROOT.

 5. APPLY ALL TRAFFIC CONTROL MEASURES PER NCDOT STANDARDS AND AS DIRECTED BY NCDOT ENGINEER.

 26. BASE DRAWMINGS BASED ON PREVIOUS ROAD CONSTRUCTION DOCUMENTS WITH FIELD VERIFICATION. ACTUAL SITE CONDITIONS MAY VARY.

 27. PLANTINGS MAY NEED TO SHIFT TO ACCOMMODATE ANY EXISTING SITE FEATURES TO REMAIN SUCH AS RIP RAP, DRAIMAGE STRUCTURES, EXISTING TREES, ETC.

SOIL PREPARATION NOTES:

- 1. ALL PLANT BEDS NOTED TO BE SEEDED AND/OR PLUGGED SHALL BE PREPARED BY THE FOLLOWING METHOD:
 a. REMOVE ALL VEGETATION, INCLUDING TURF GRASS, WEEDS, WOODY PLANTS OR OTHER UNWANTED VEGETATION
 b. TILL SUBGRADE TO A DEPTH OF 6" TO BREAK UP COMPACTION
 c. SPREAD 2 INCHES OF ORGANIC COMPOST OVER TILLED SUBGRADE
 d. MIX COMPOST AND SUBGRADE THOROUGHLY UNTIL WELL COMBINED, TO A MEDIUM-TO-FINE TEXTURE
 e. ENSURE THAT PLANTING SOILS ARE FREE OF LARGE CLUMPS, ROOTS, STICKS, ROCKS, STONES, BUILDING MATERIALS, TOXIC SUBSTANCES, AND
 ANY OTHER LUMANTED MATERIALS
- 2. TAKE CAUTIONS TO ENSURE THAT THE PLANTING SOIL DOES NOT BECOME COMPACTED THROUGH THE PROCESS OF SEEDING OR PLANTING
 5. FOR ANY AREA OF PLANTING SOIL THAT BECOMES OVERLY COMPACTED, BREAK UP COMPACTION WITH MINIMAL TILLING OR OTHER APPROVED.

THIS DRAWING PREPARED AT T CORPORATE DFFICE 1001 Boulders Parkway, Suite 300 | Richm TEL 804,200,6500 FAX 804,560,1016 www

4/19/2022


SDAVIS LASCO/DAV I. BLASCO SCALE


AS SHOWN


BYPAS


SHEBORO


45391 L-0.0

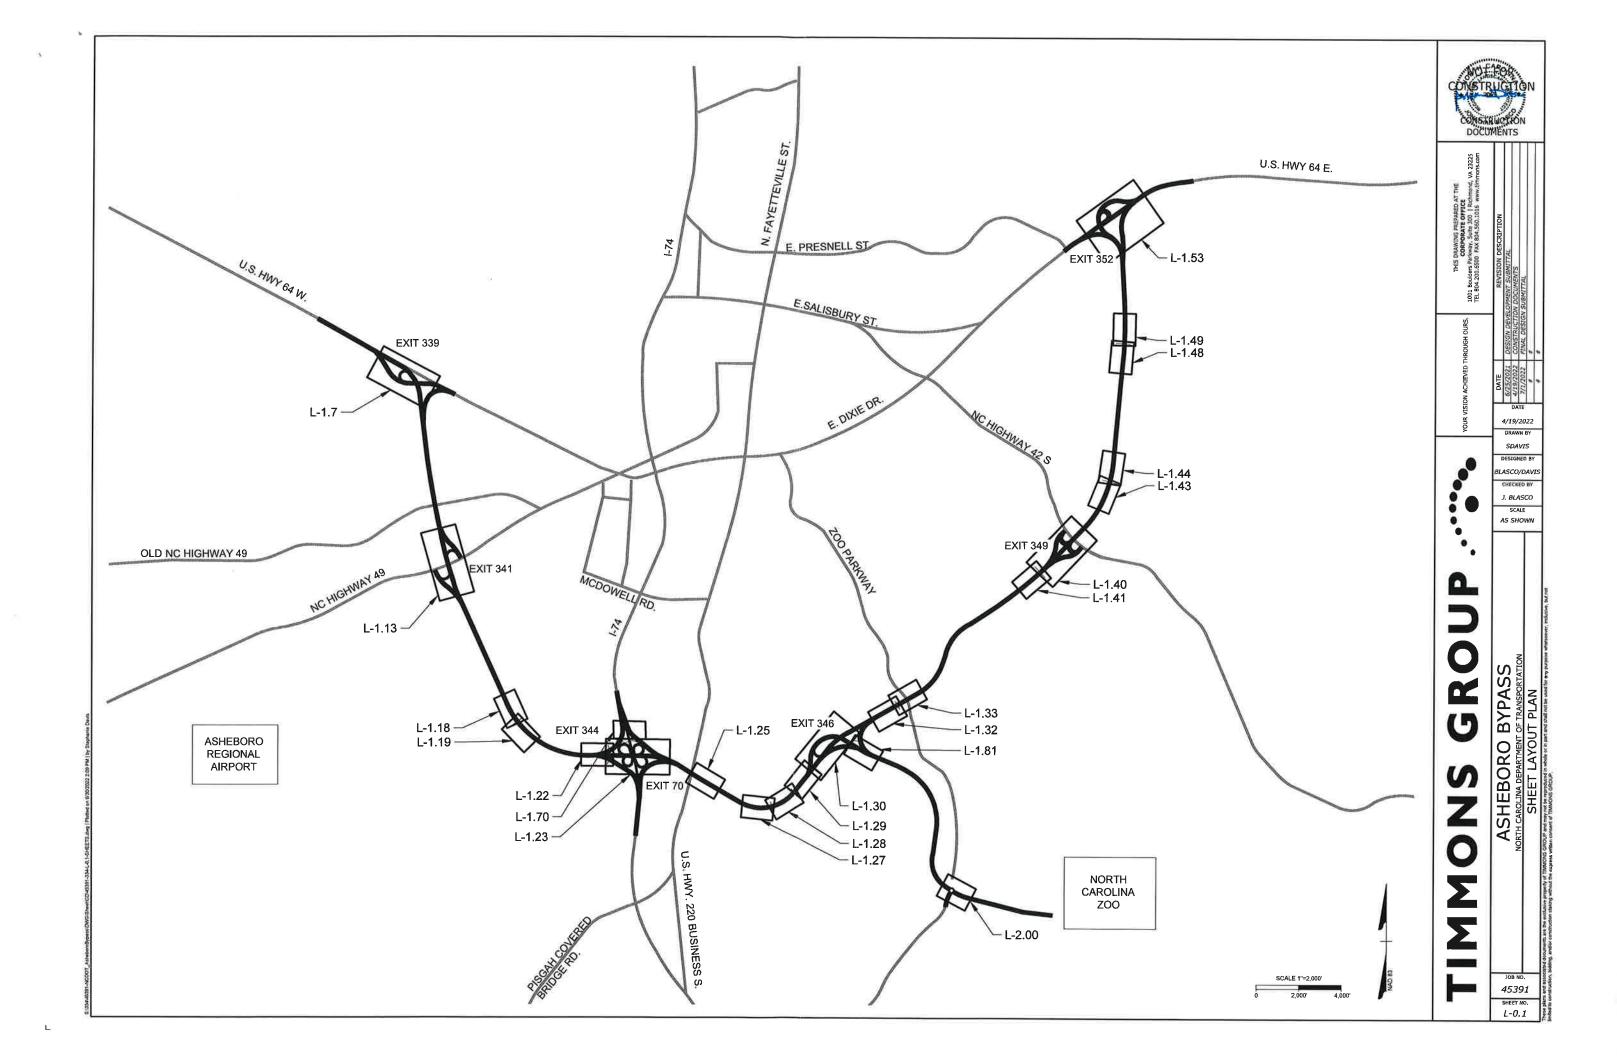


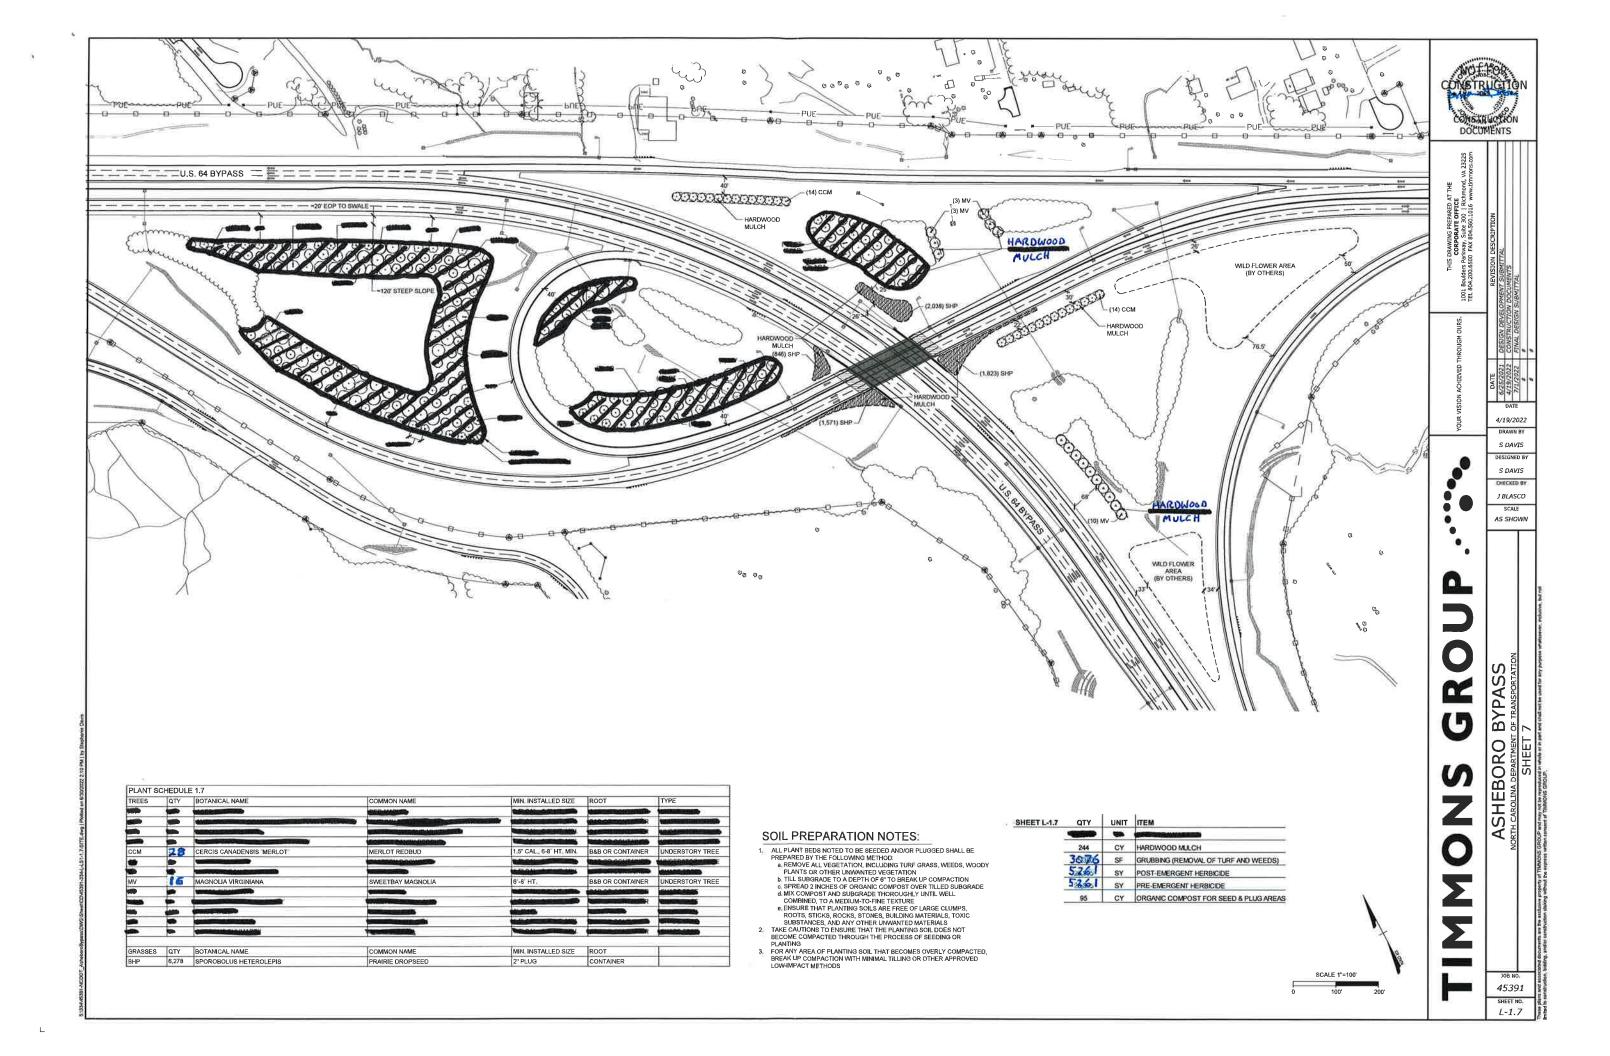


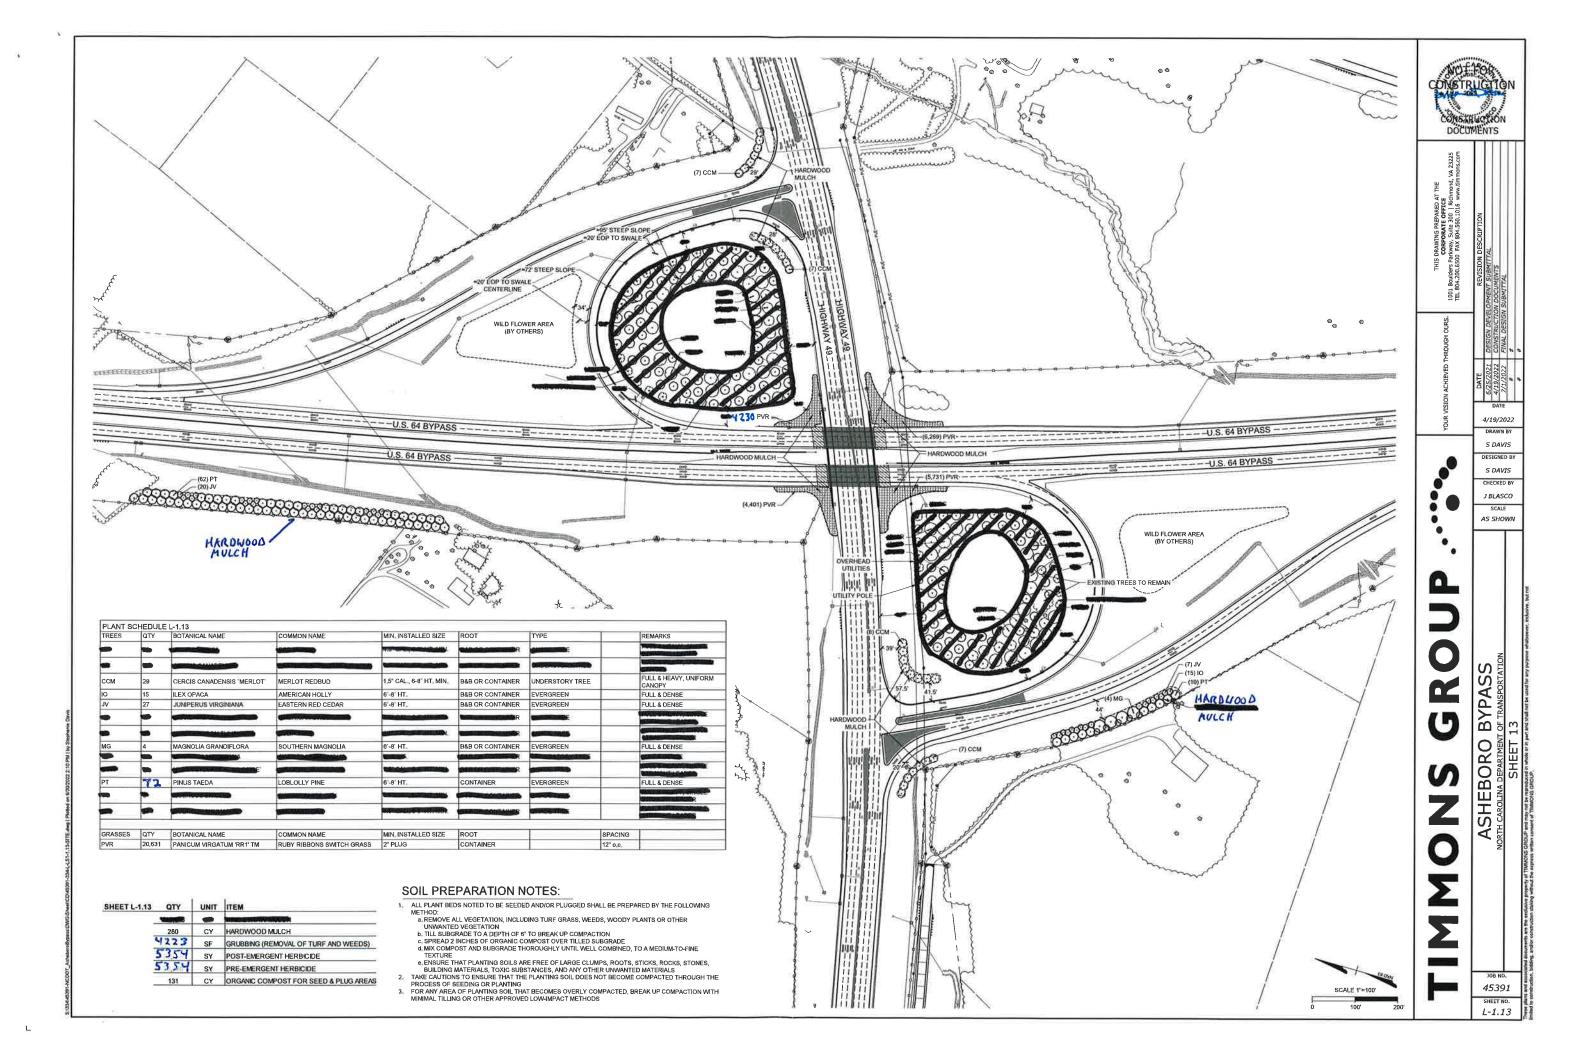


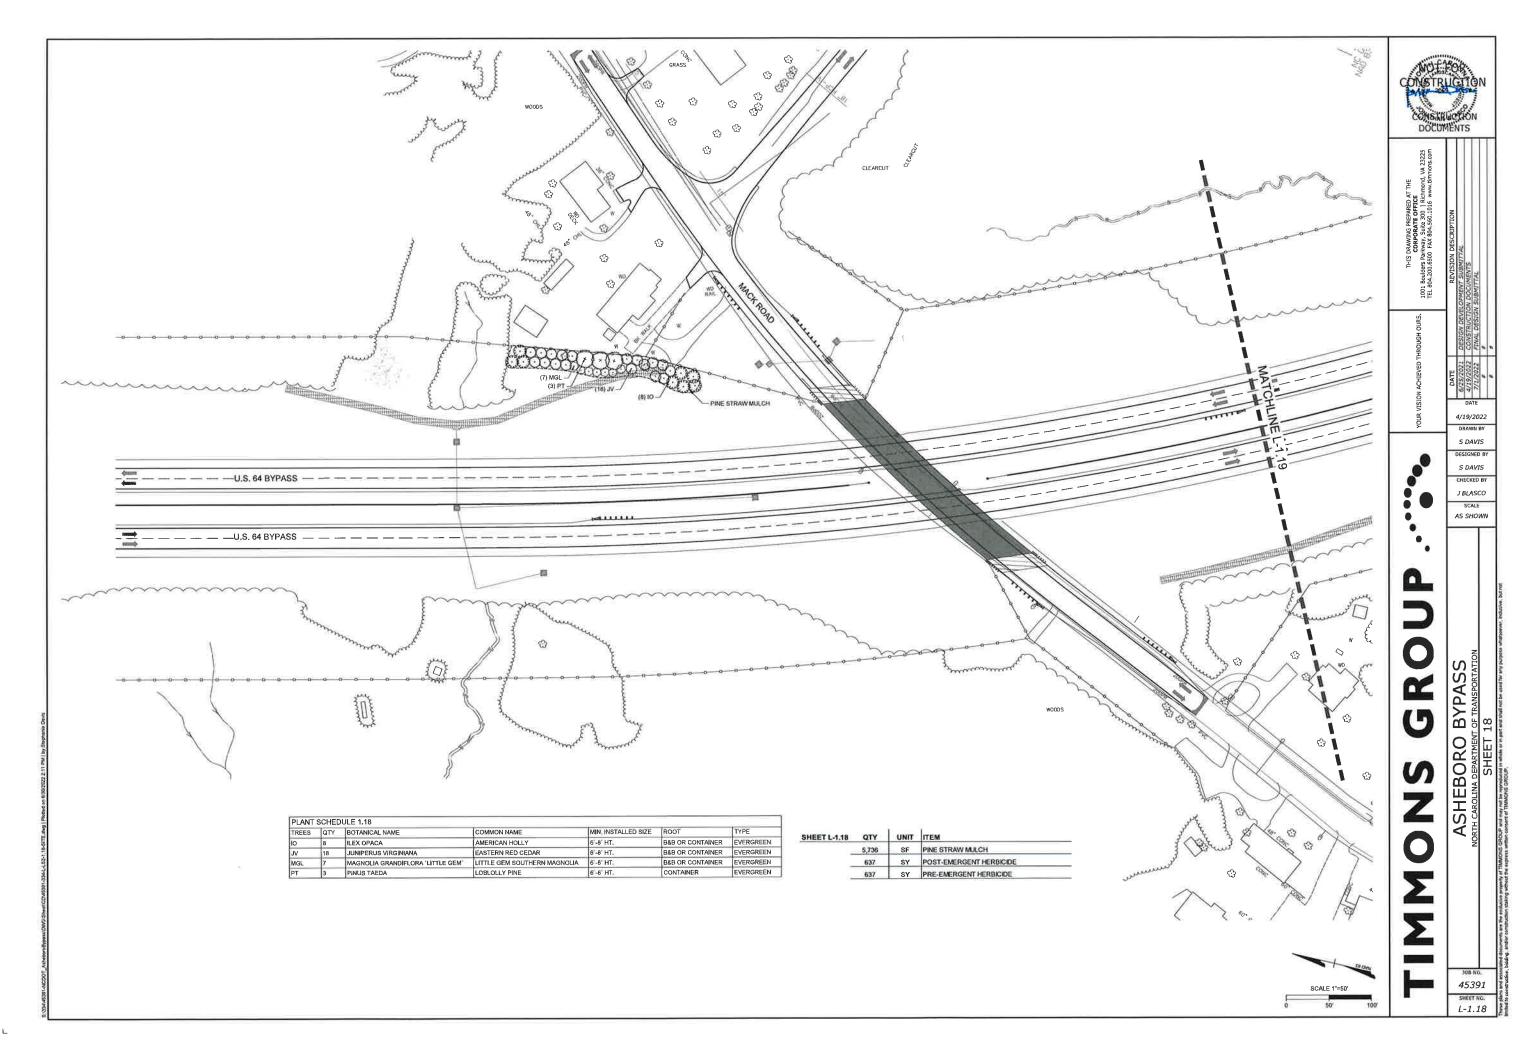

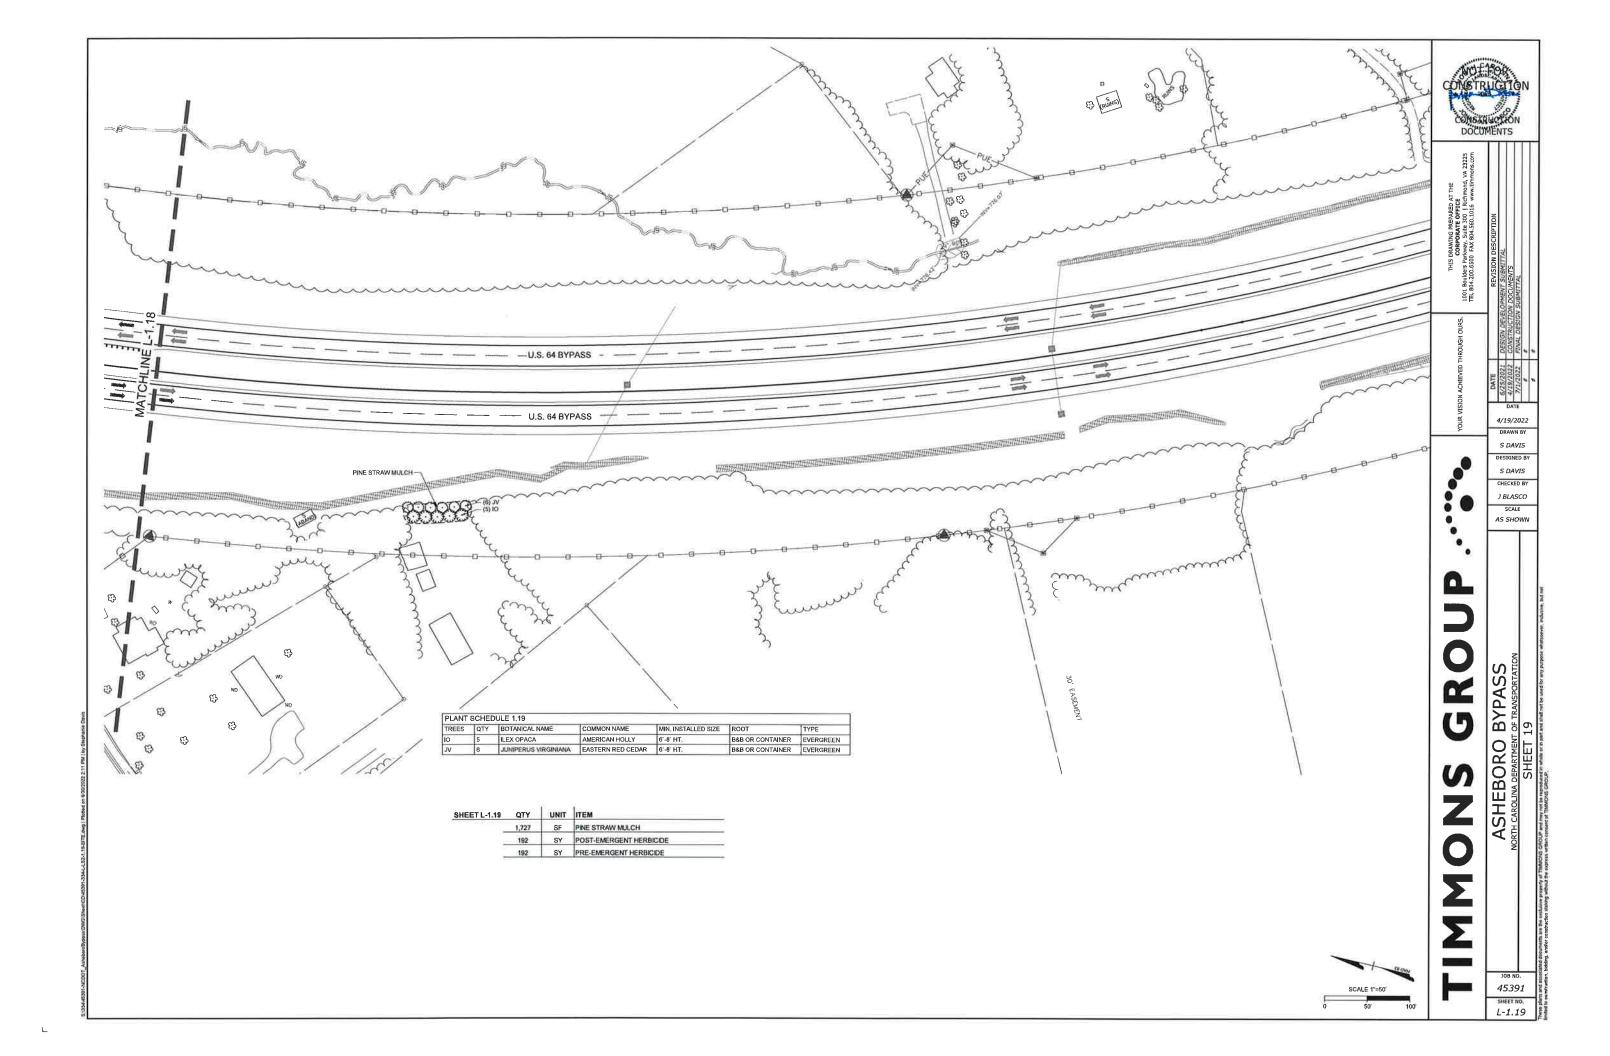

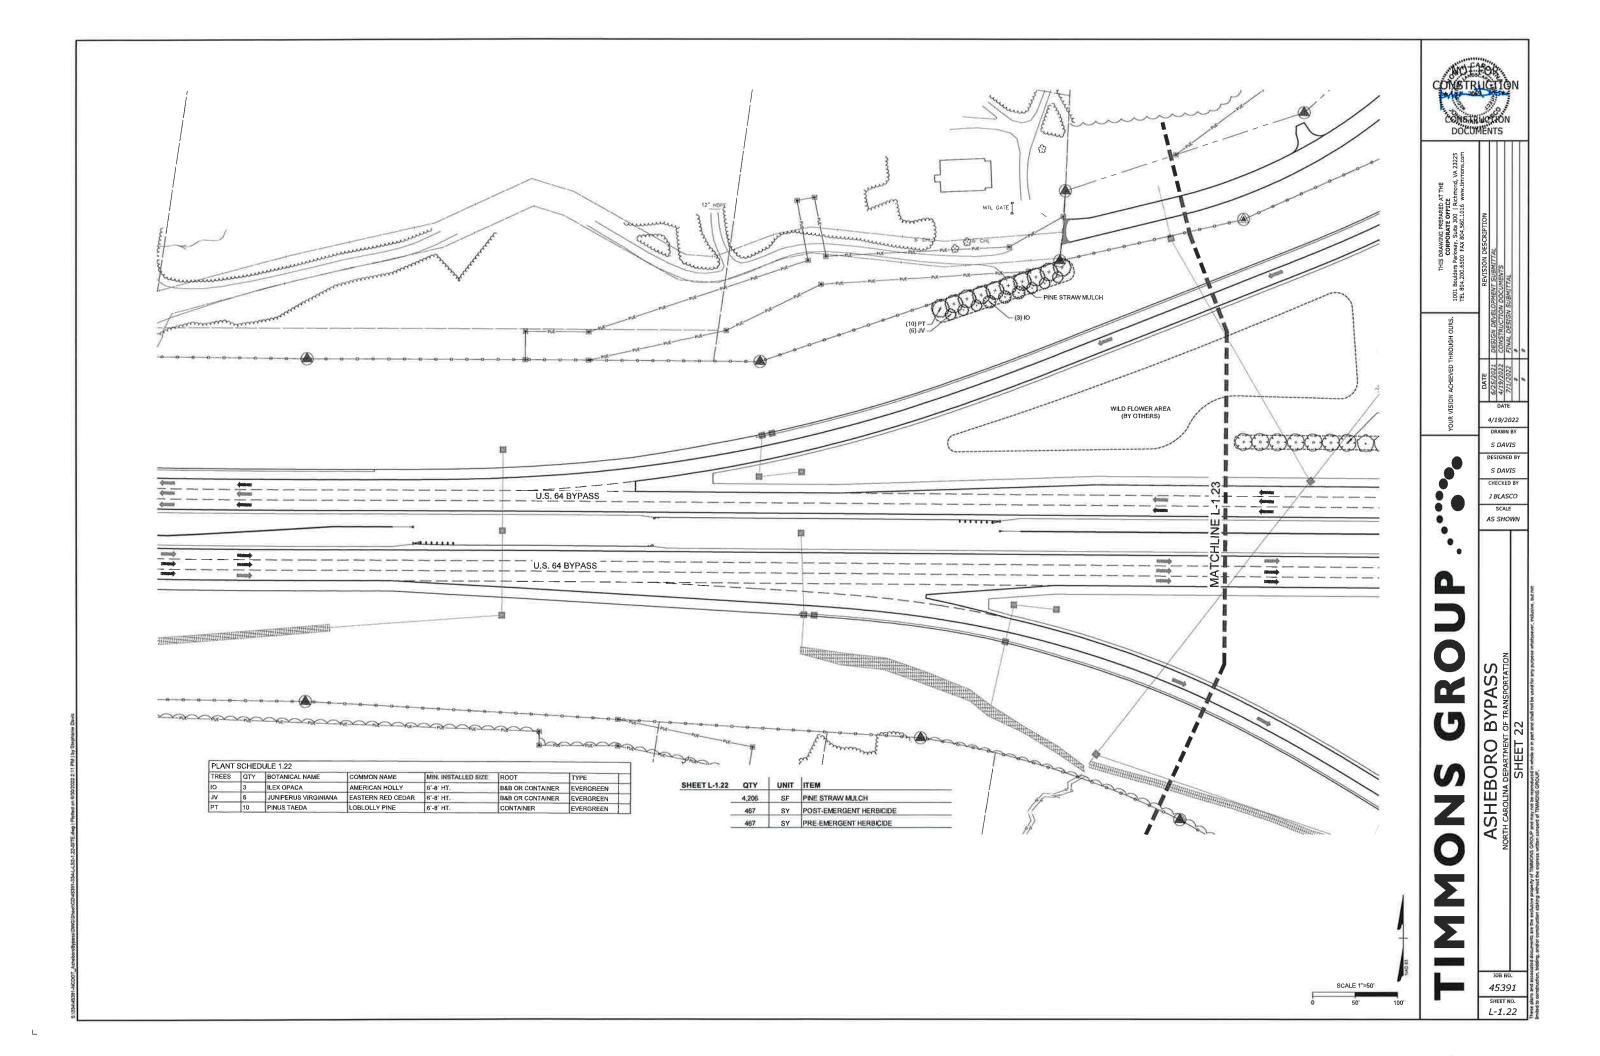

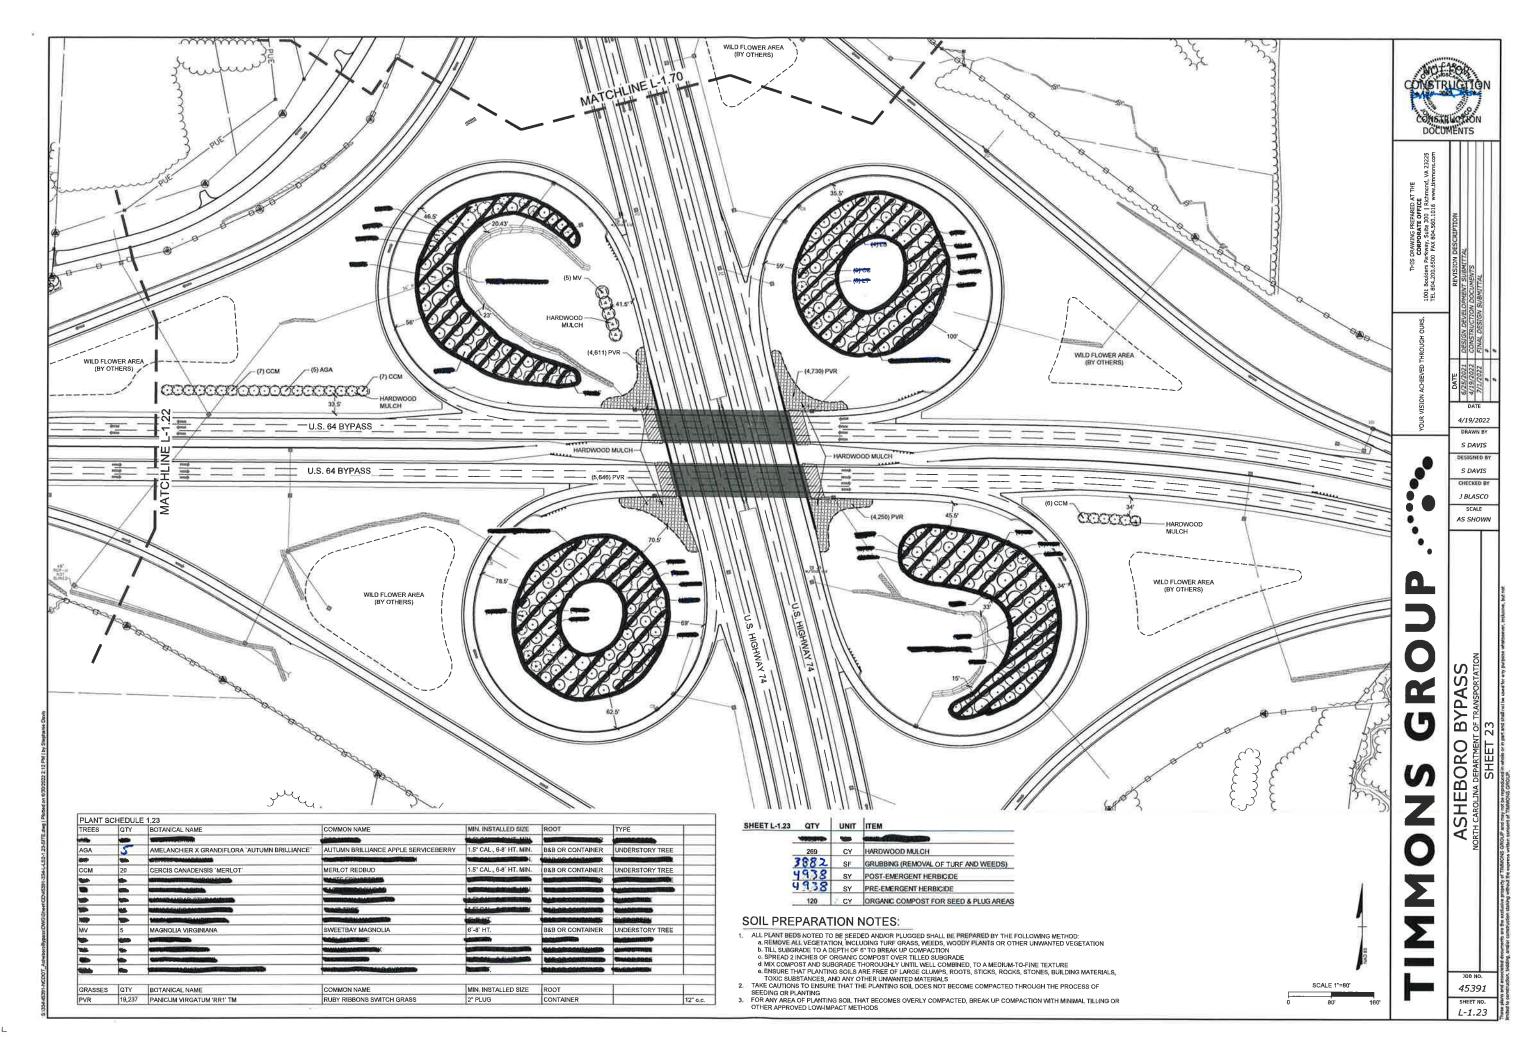

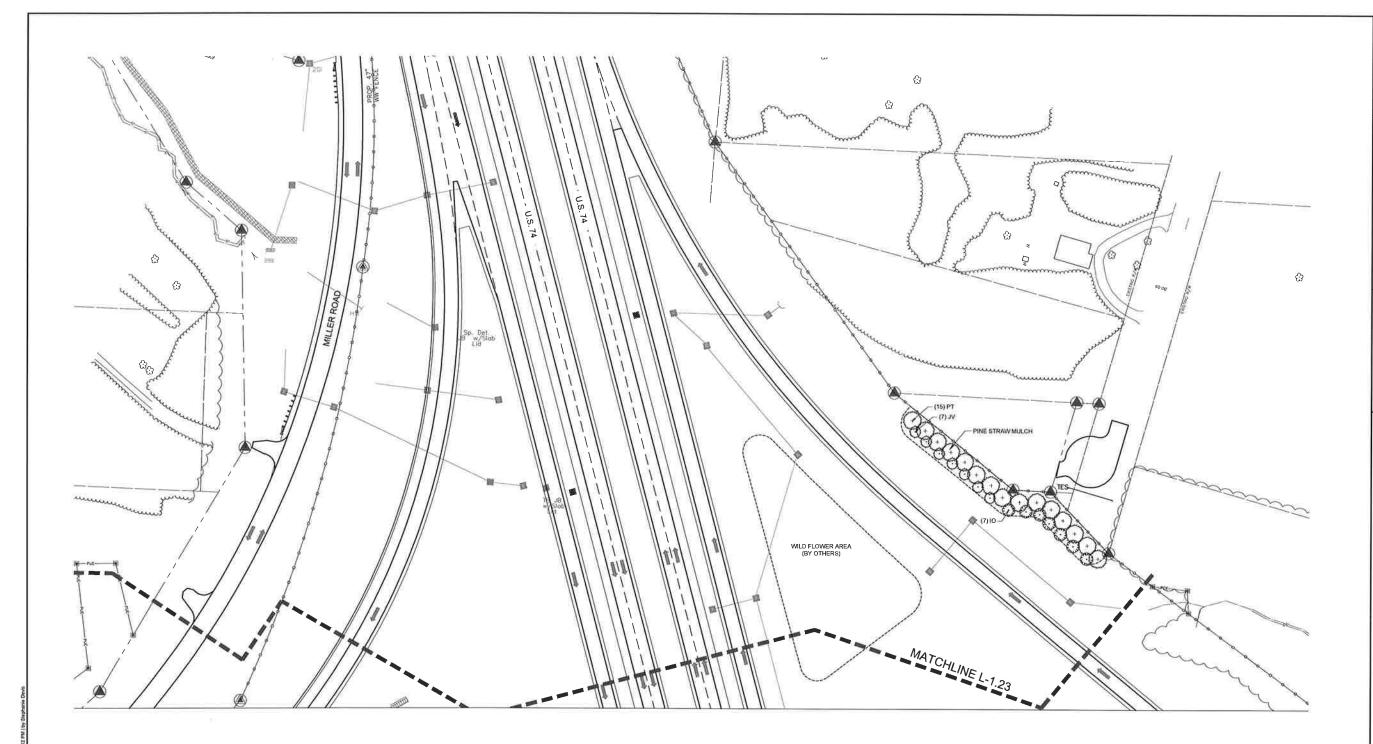

| TREES | Taty | BOTANICAL NAME | COMMON NAME | MIN. INSTALLED SIZE | ROOT | TYPE |
|-------|------|----------------------|-------------------|---------------------|------------------|-----------|
| 10 | 7 | ILEX OPACA | AMERICAN HOLLY | 6'-8' HT. | B&B OR CONTAINER | EVERGREEN |
| JV | 7 | JUNIPERUS VIRGINIANA | EASTERN RED CEDAR | 6"-8" HT. | B&B OR CONTAINER | EVERGREEN |
| PT | 15 | PINUS TAEDA | LOBLOLLY PINE | 6'-8' HT. | CONTAINER | EVERGREEN |


| SHEET L-1.70 | QTY | UNIT | ITEM |
|--------------|-------|------|-------------------------|
| _ | 8,722 | SF | PINE STRAW MULCH |
| | 969 | SY | POST-EMERGENT HERBICIDE |
| | 969 | SY | PRE-EMERGENT HERBICIDE |


DATE
4/19/2022
DRAWN BY S DAVIS S DAVIS CHECKED BY J BLASCO SCALE AS SHOWN GROU ASHEBORO BYPASS
DRTH CAROLINA DEPARTMENT OF TRANSPORTATIC
SHEET 70 ONS


308 NO. 45391 SHEET NO. L-1.70

THIS DRAWING PREPARED AT THE CORPOBATE OFFICE 1001 Boulders Parkway, Suite 300 | Richmond, VA 23225 TEL 804,200,5500 FAX 804,560,1016 www.inmnons.com


SCALE 1"=50"

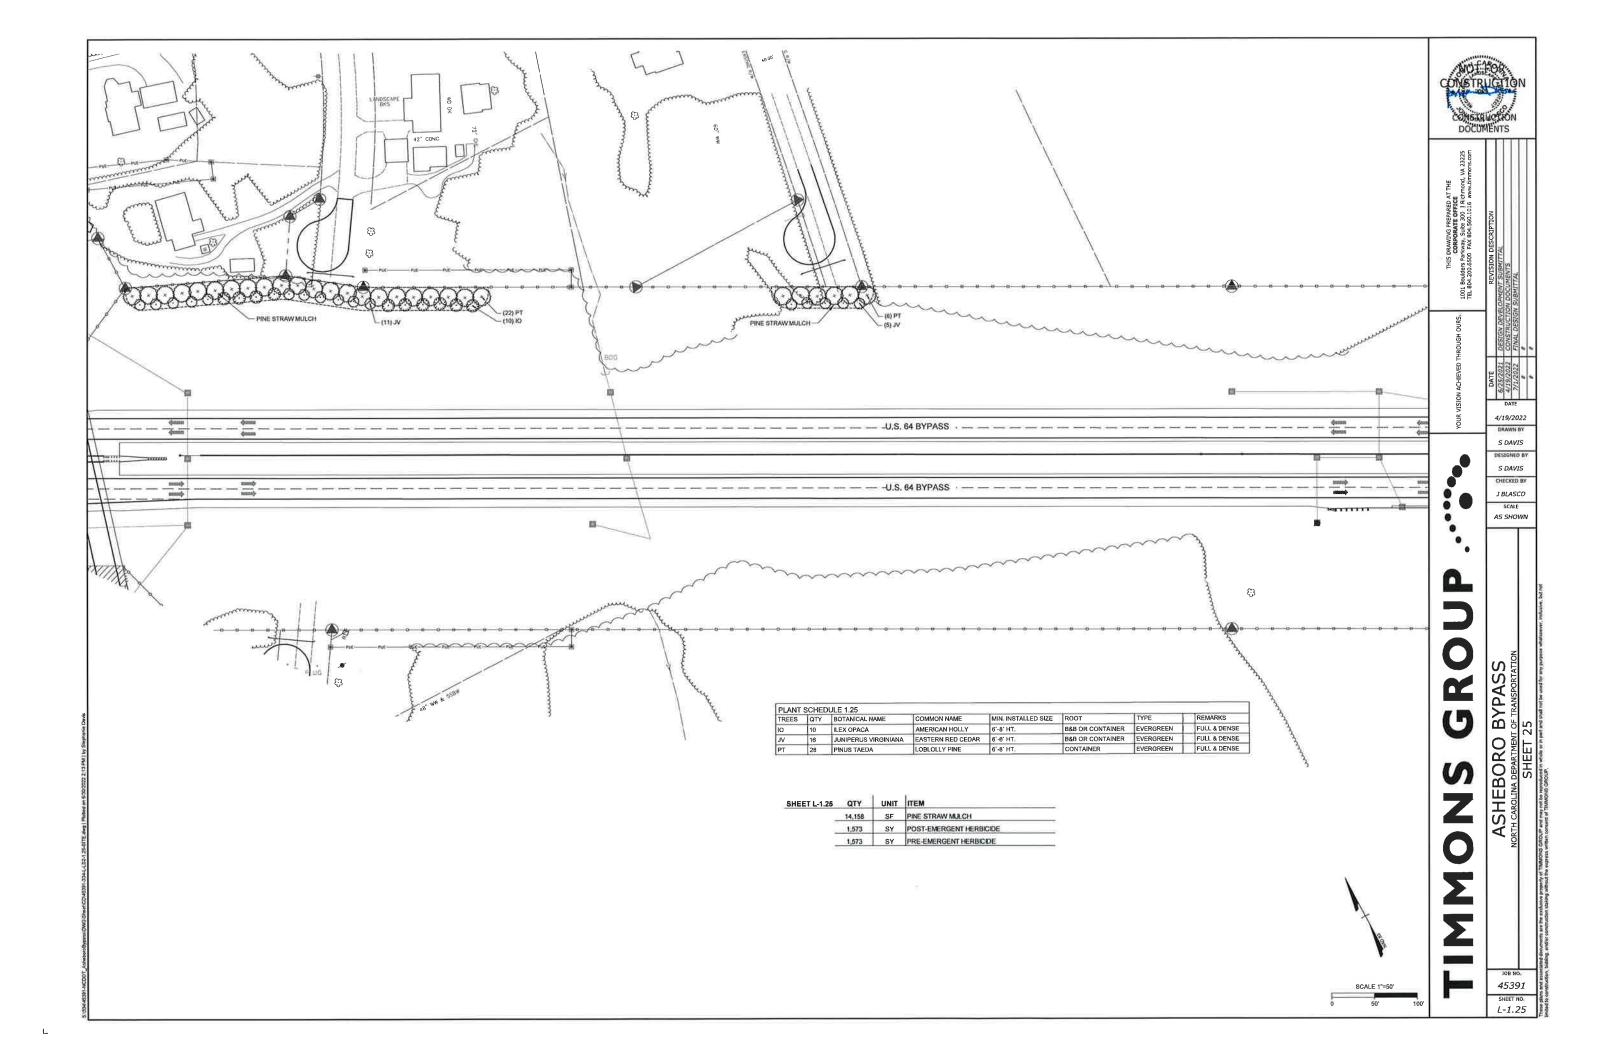


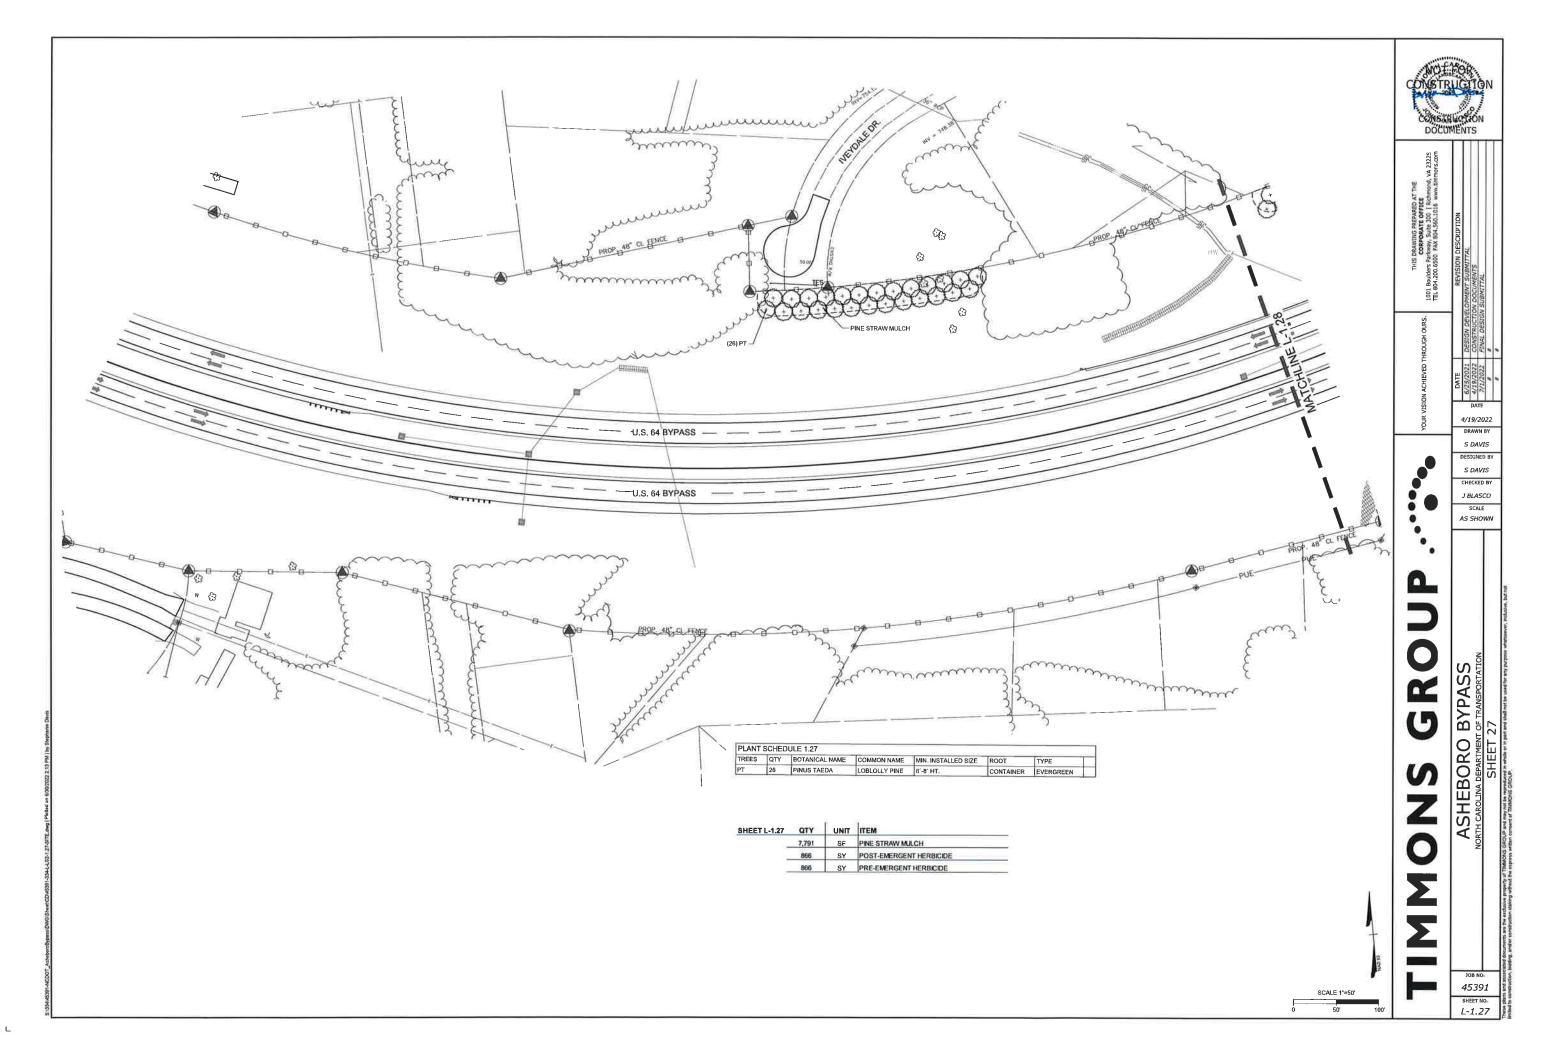

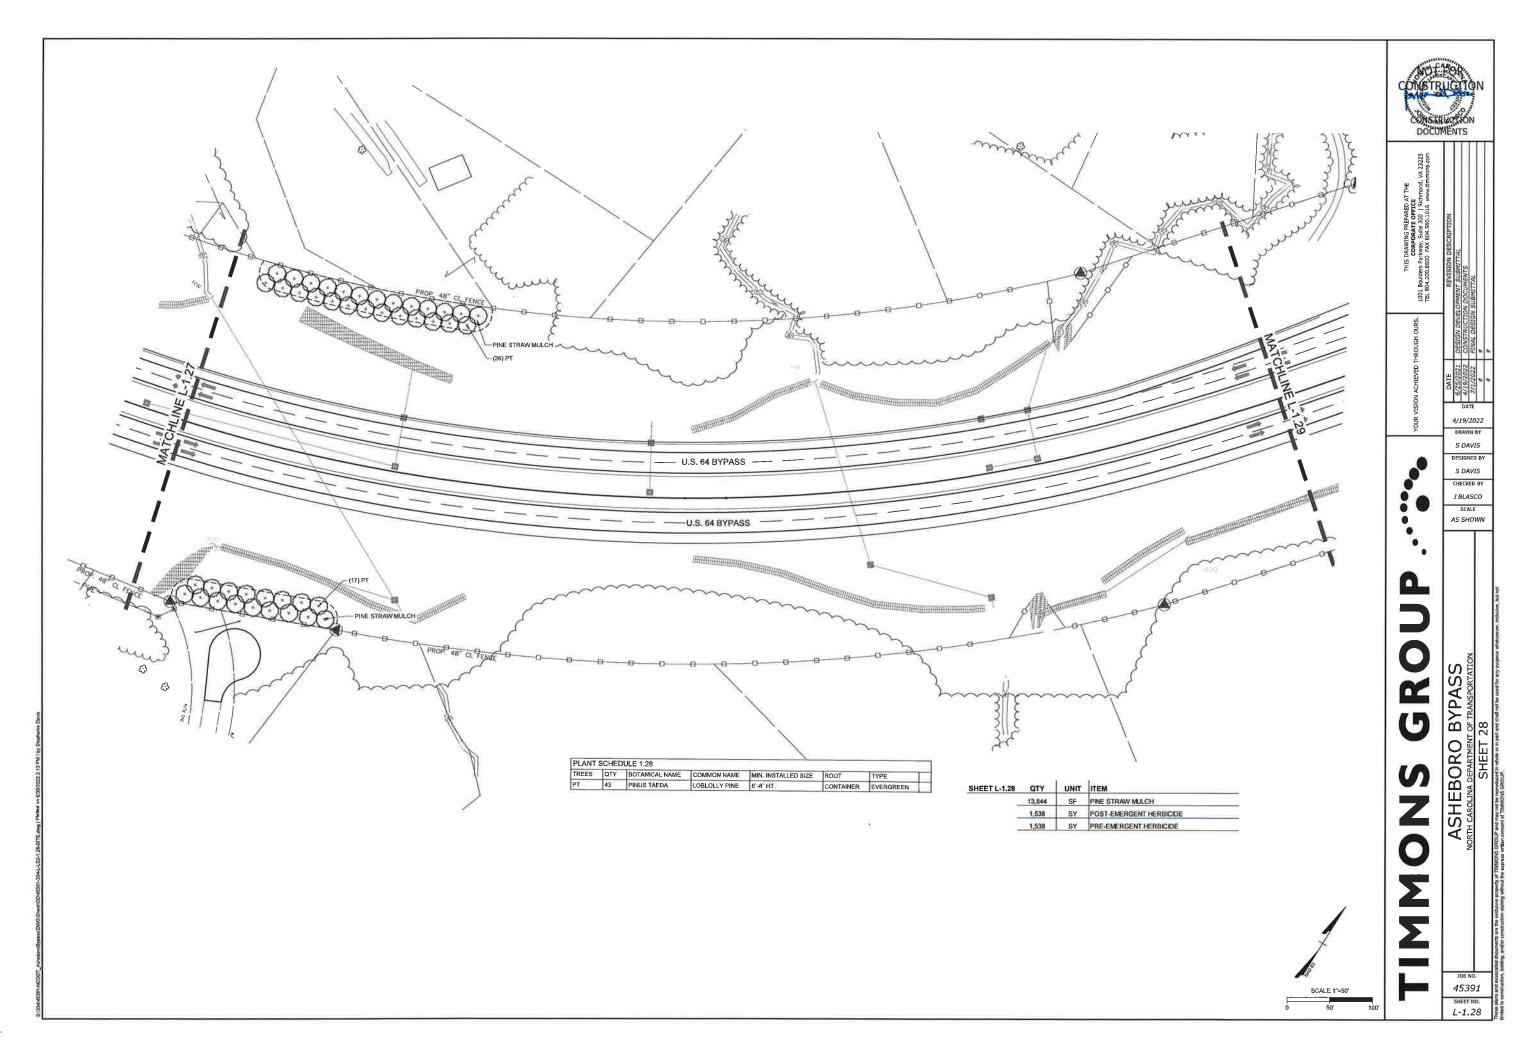


L

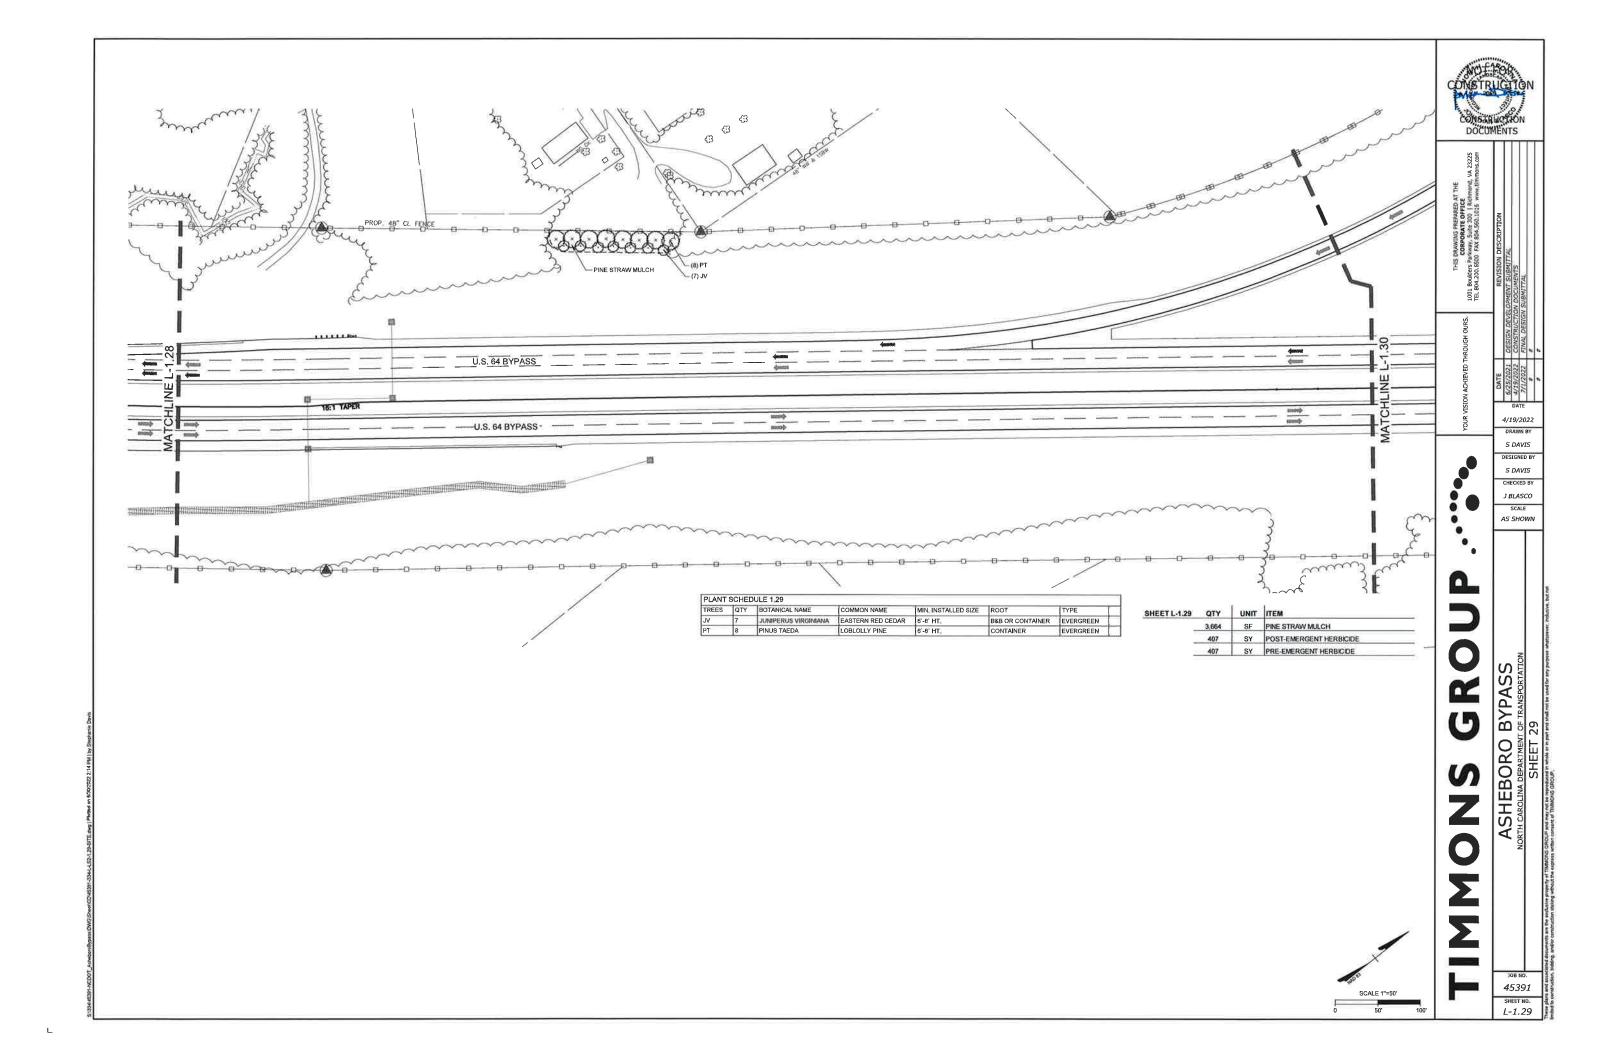


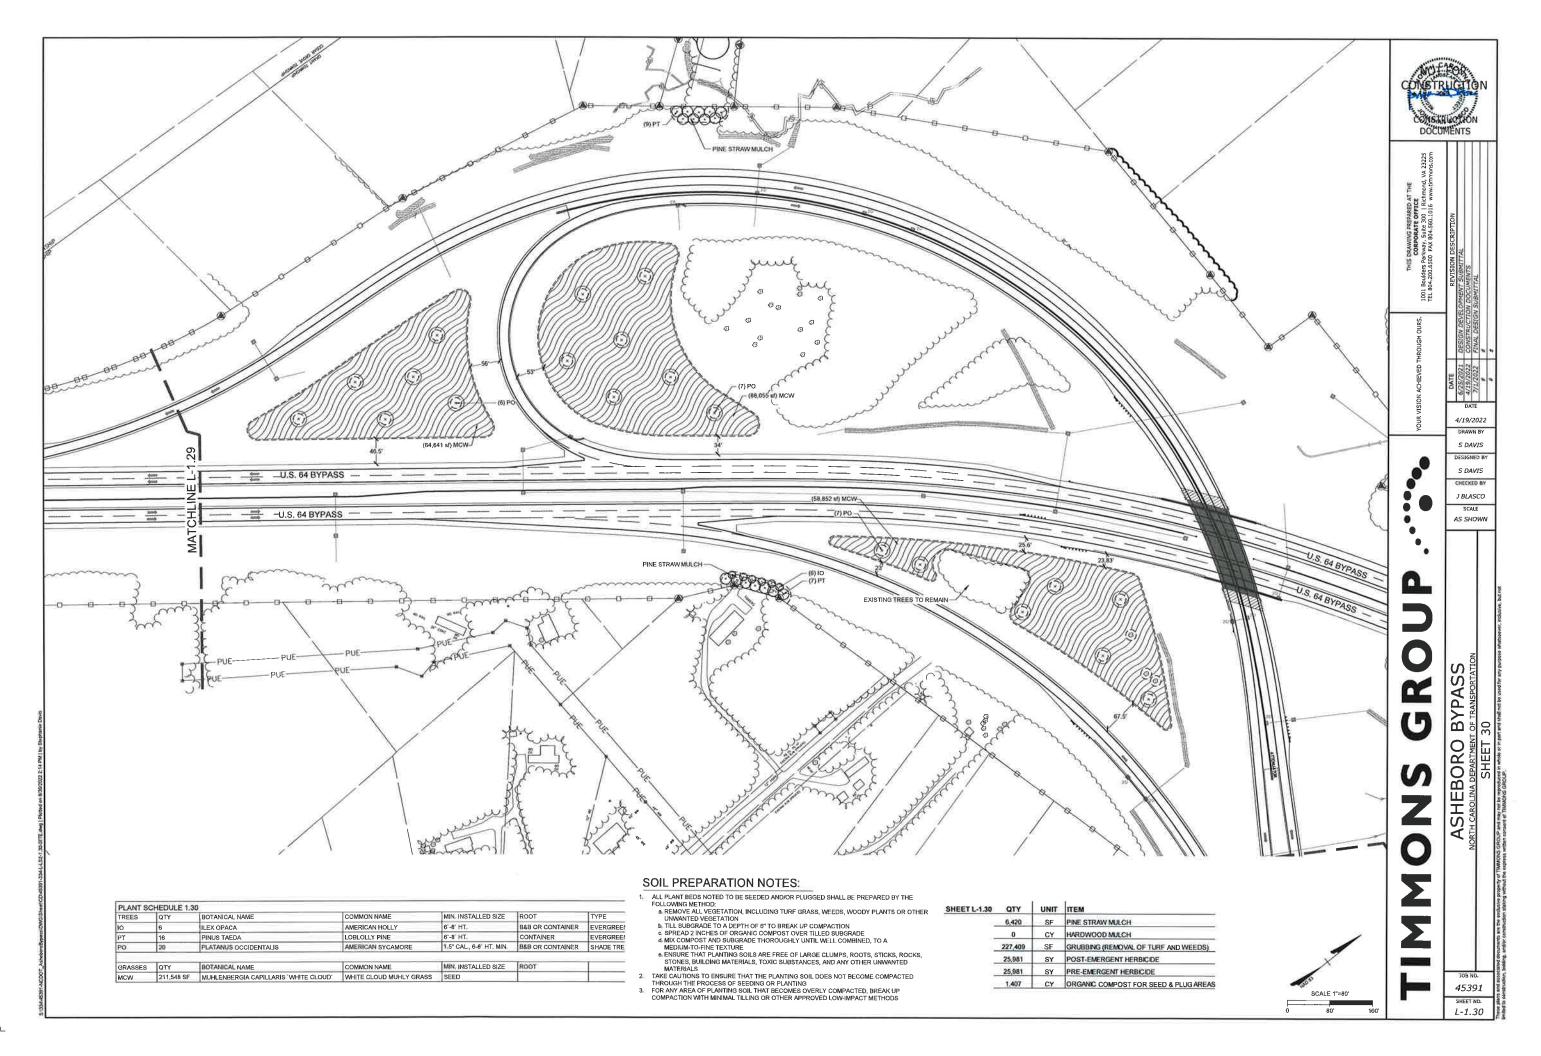


- 1

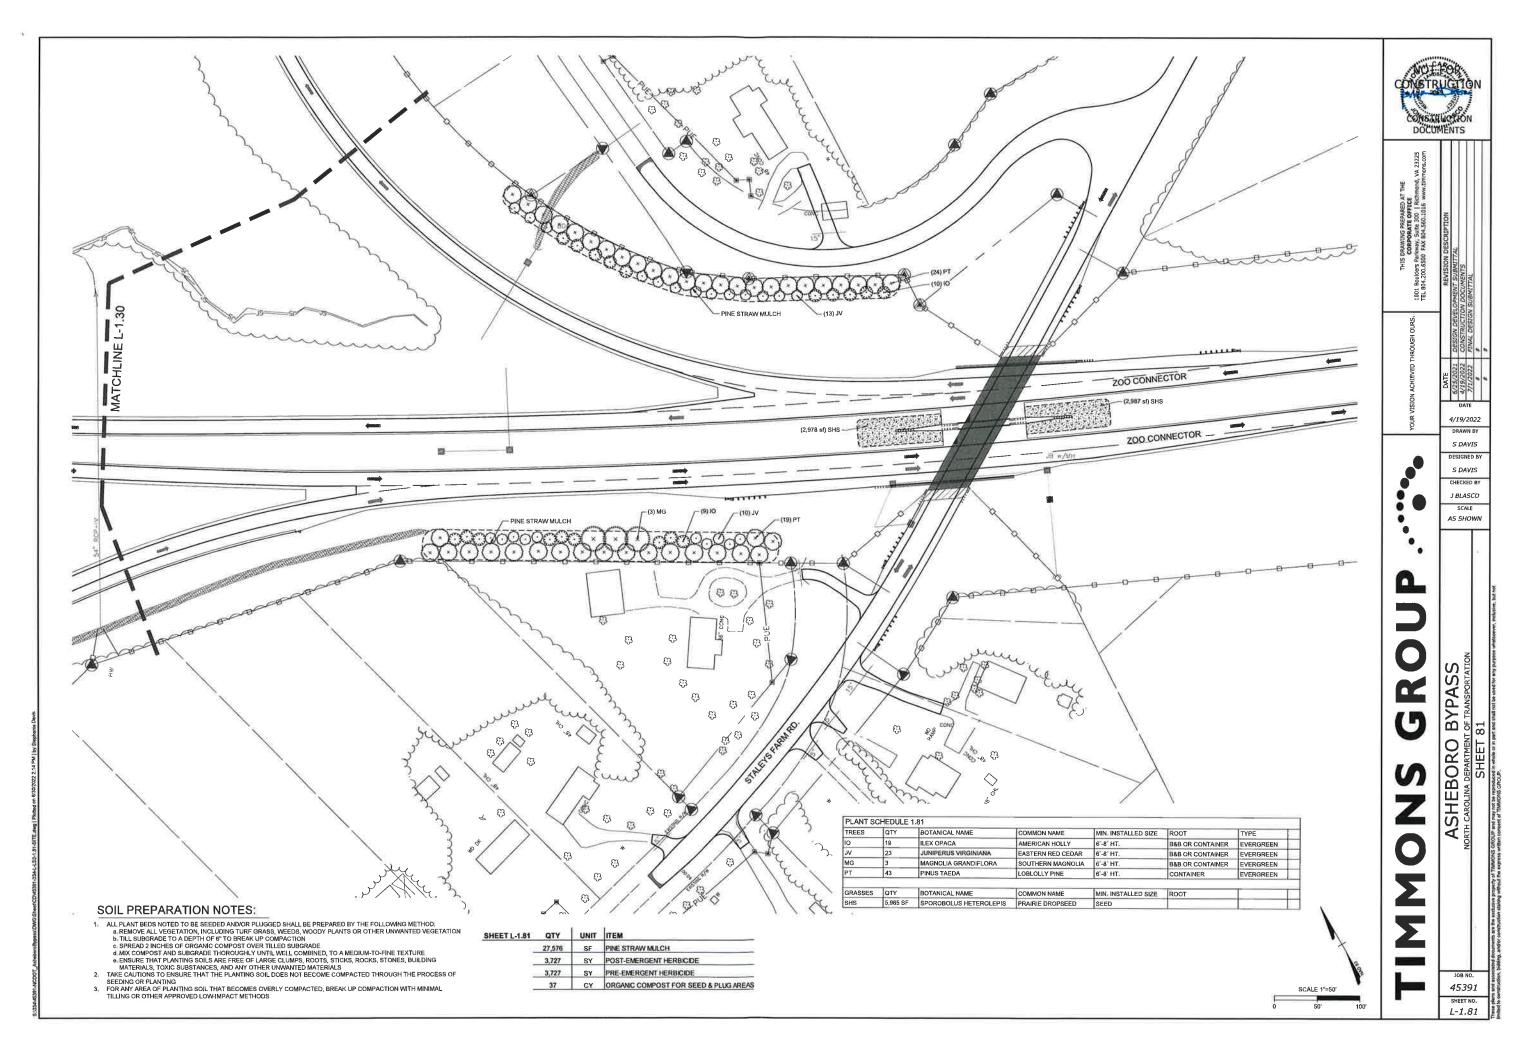


L

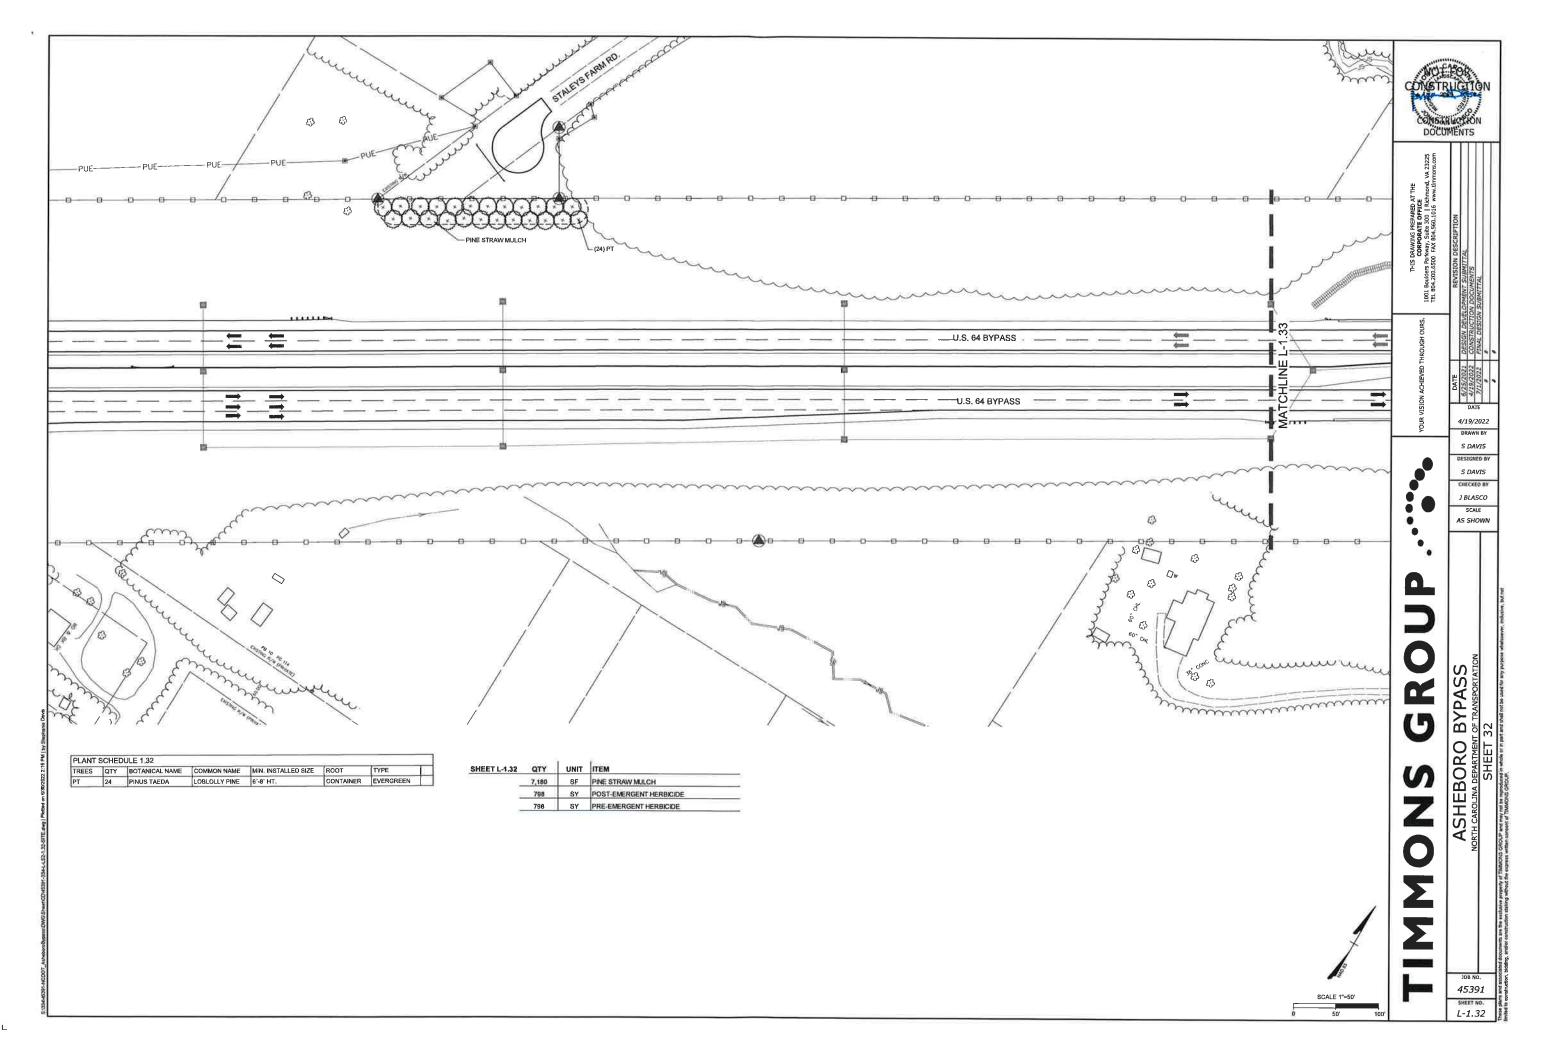

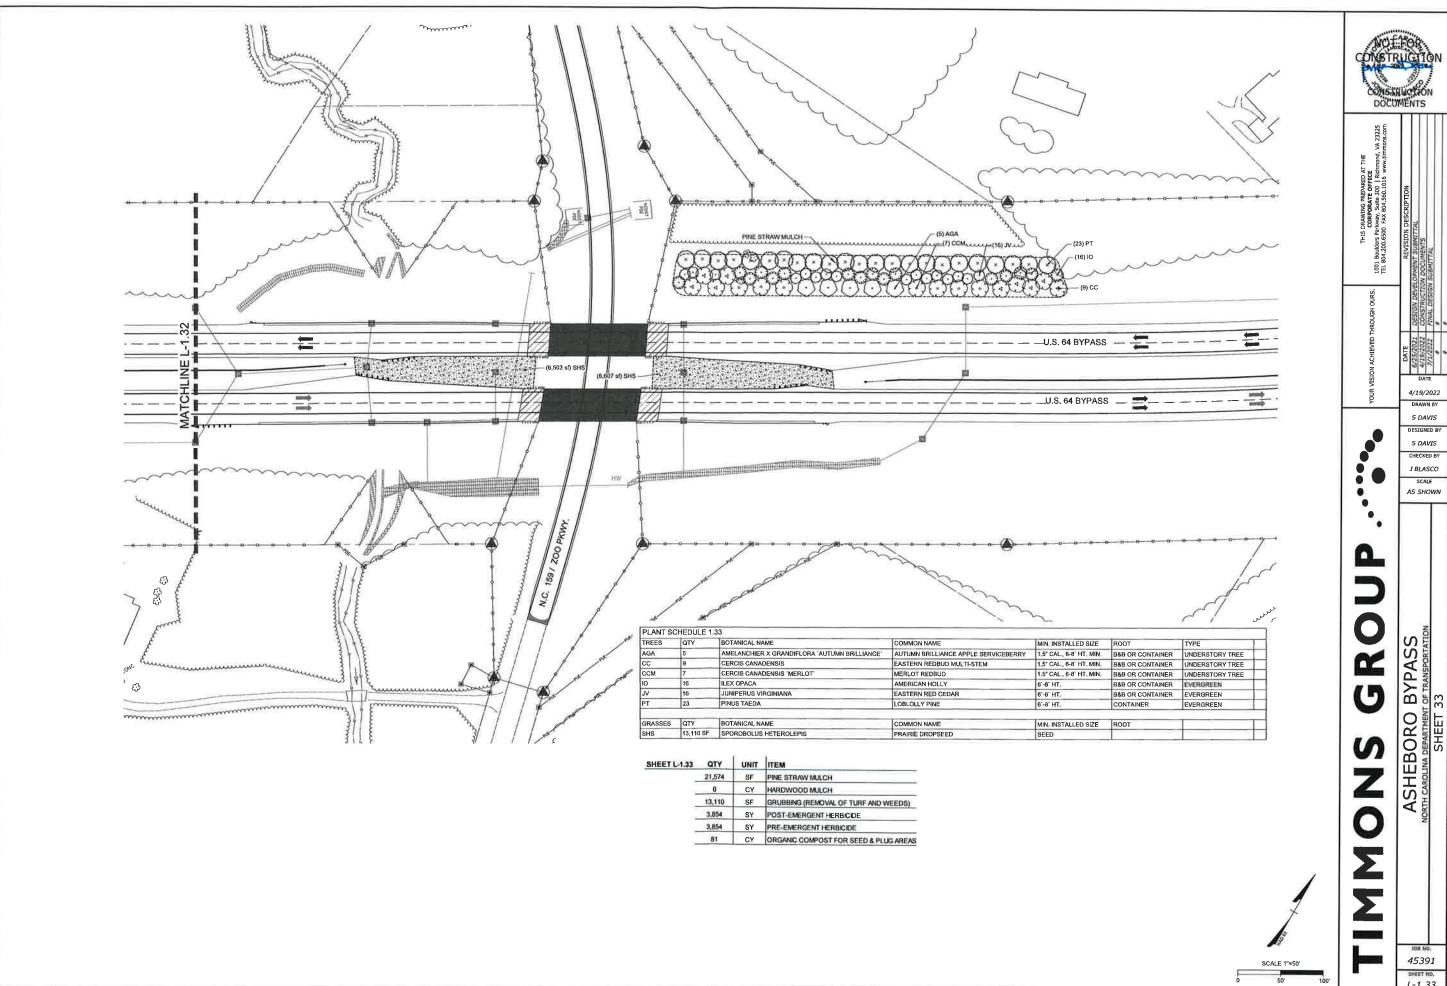

L-1.33

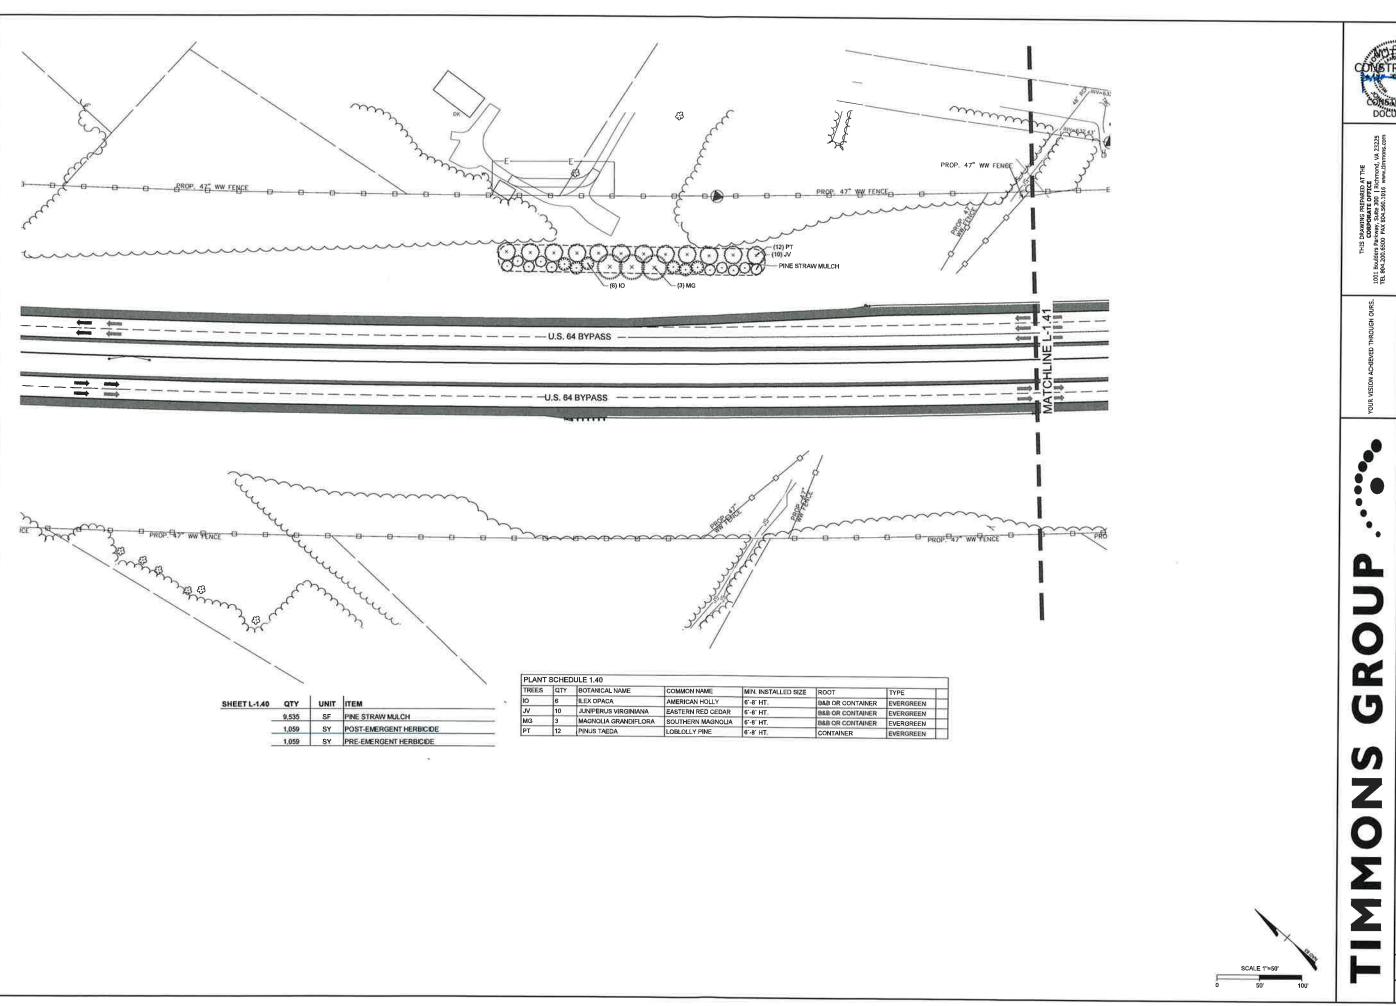

4/19/2022


S DAVIS S DAVIS


CHECKED BY J BLASCO

SCALE AS SHOWN

ASHEBORO BYPASS RTH CAROLLINA DEPARTMENT OF TRANSPORTATION

45391 SHEET NO. L-1.40

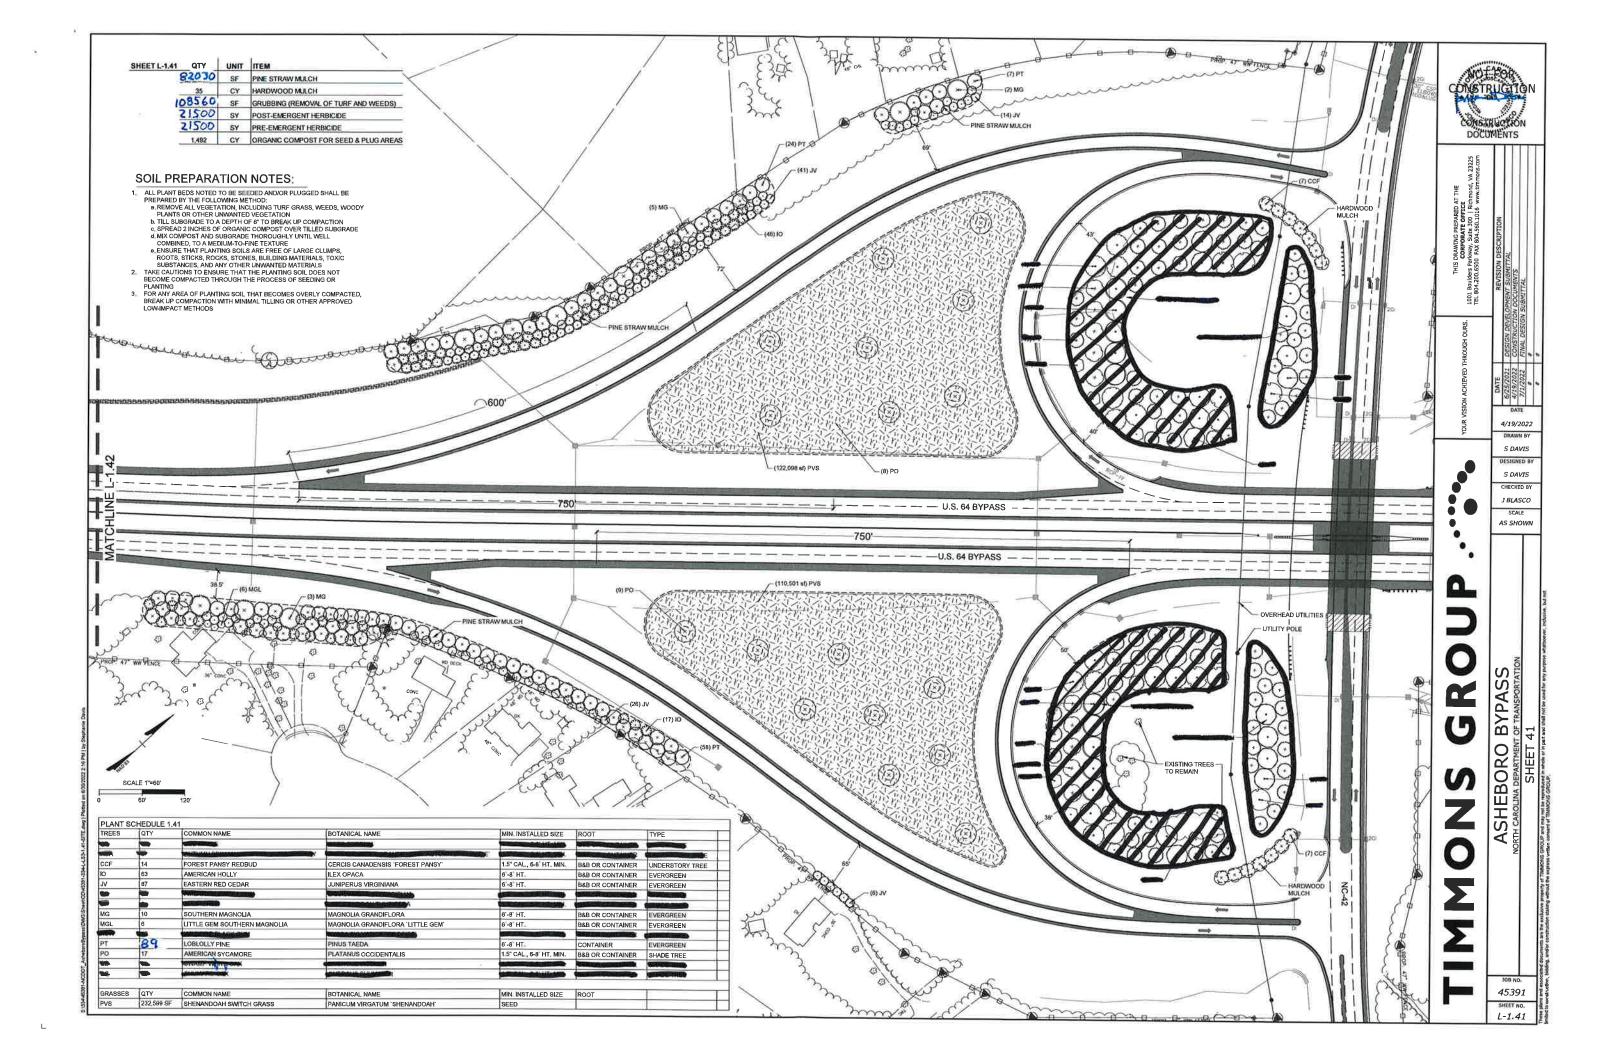

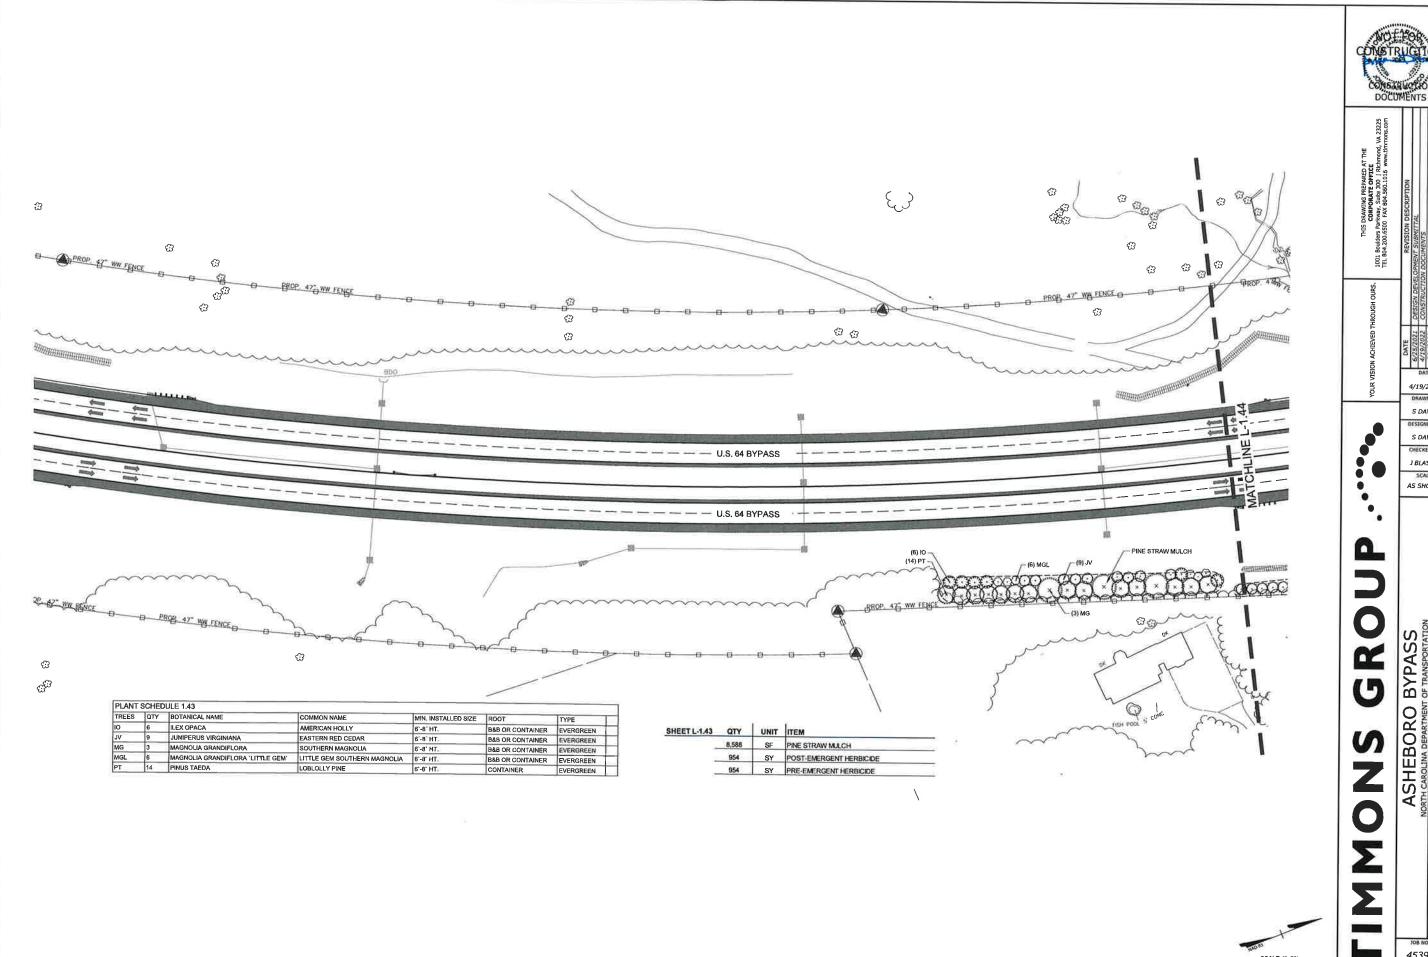


4/19/2022 DRAWN BY

S DAVIS DESIGNED BY S DAVIS

J BLASCO SCALE AS SHOWN

45391 SHEET NO. L-1.43

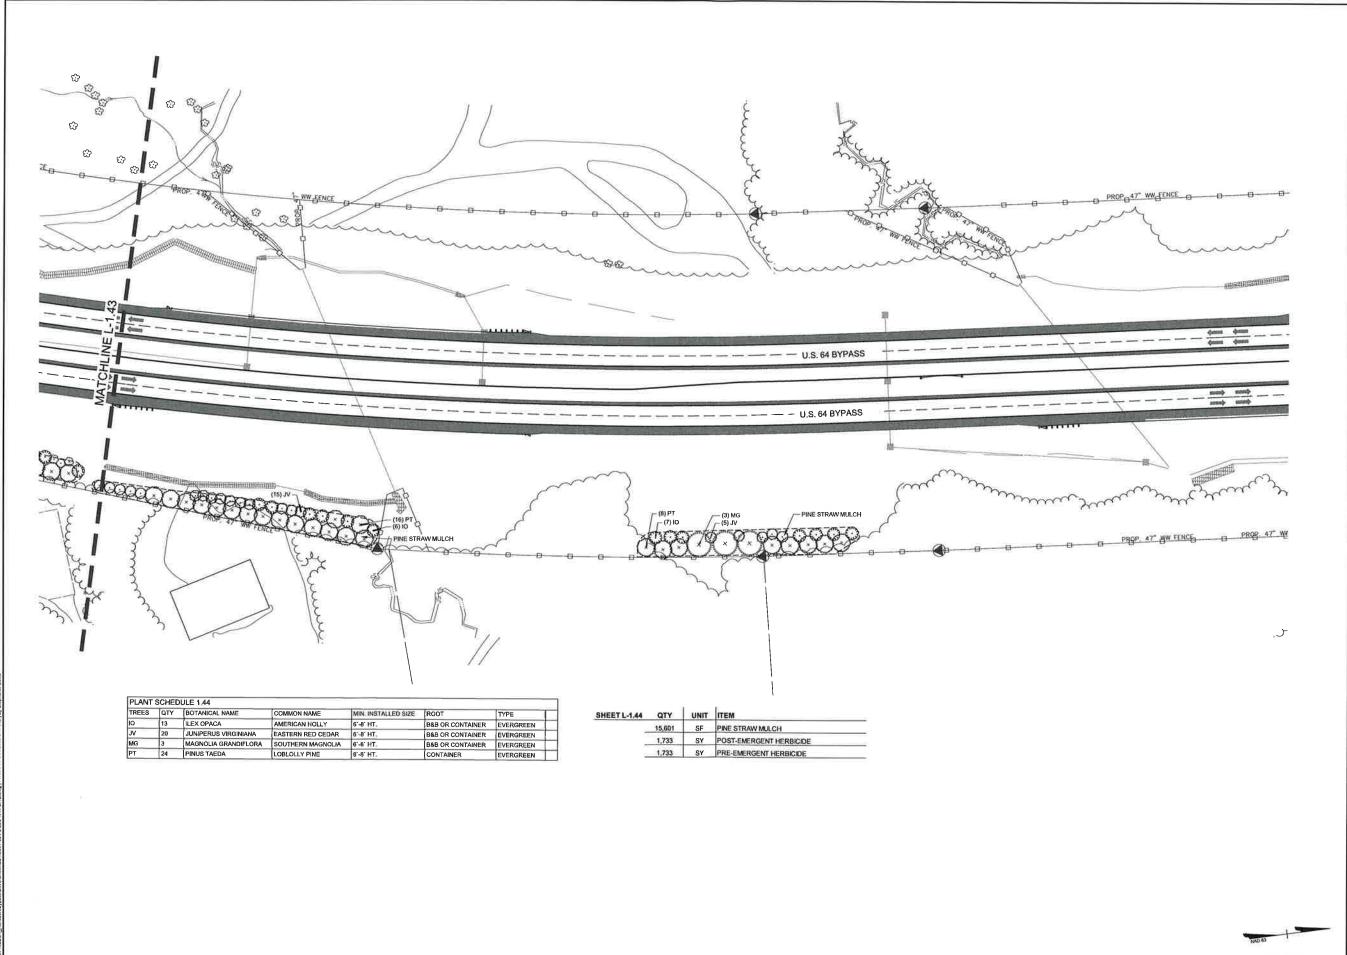

THIS DRAWING PREPABED AT THE CORPOSATE OFFICE 1001 Boulders Parkway, Sulta 300 | Richmond, VA 23225 TEL 804-200.6530 FAX 804,560.1016 www.limmons.com


4/19/2022 S DAVIS S DAVIS


CHECKED BY J BLASCO SCALE AS SHOWN


| •. |
|----------------------------|
| Δ |
| |
| 0 |
| 1 1 1 1 1 1 1 1 1 1 |
| S |
| Z |
| 0 |
| Σ |
| 7 |


ASHEBORO BYPASS
NORTH CAROLINA DEPARTMENT OF TRANSPORTATION


45391 SHEET NO. L-1.44

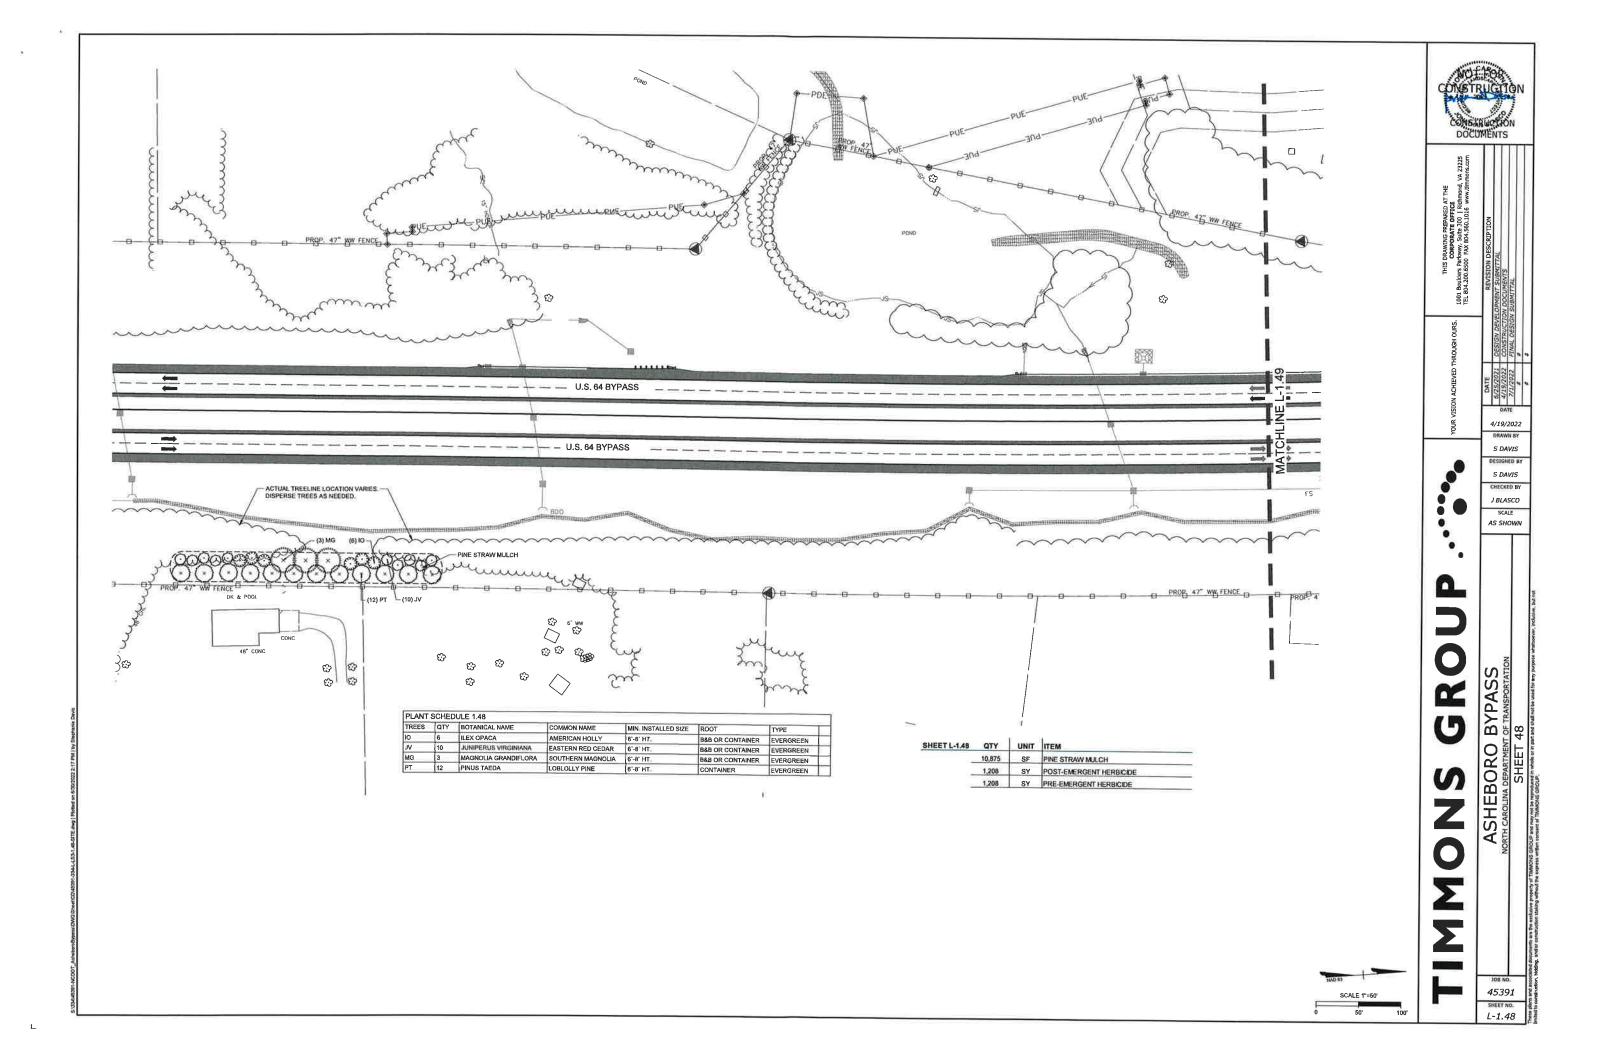


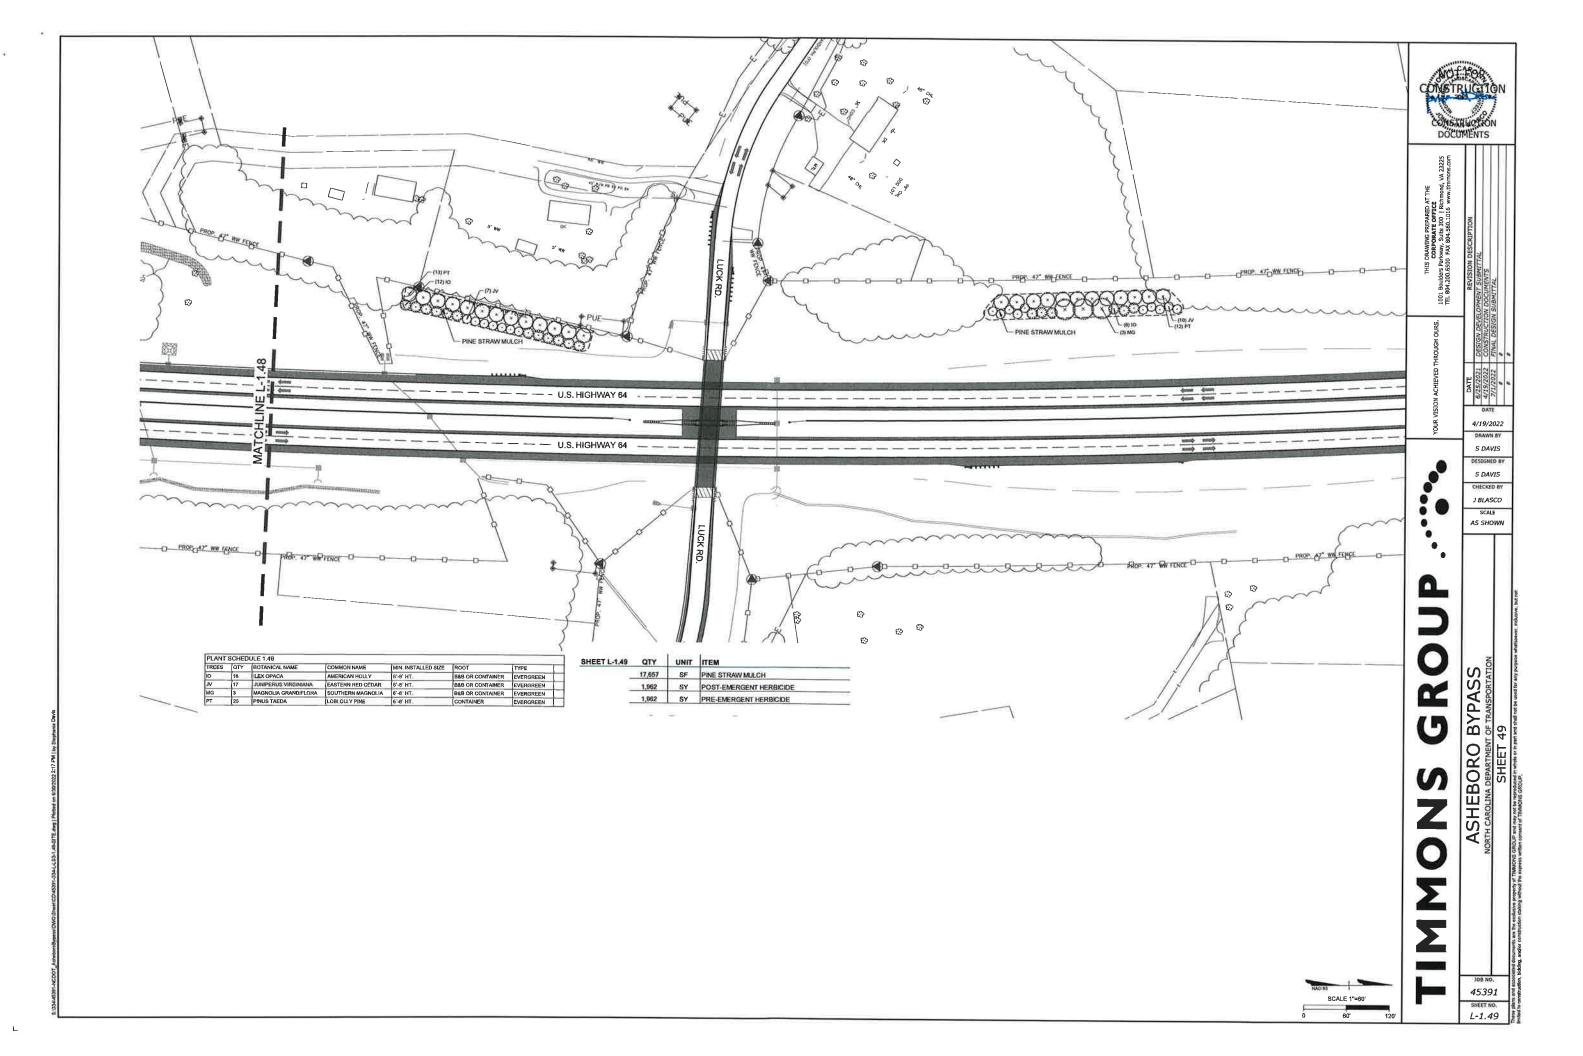

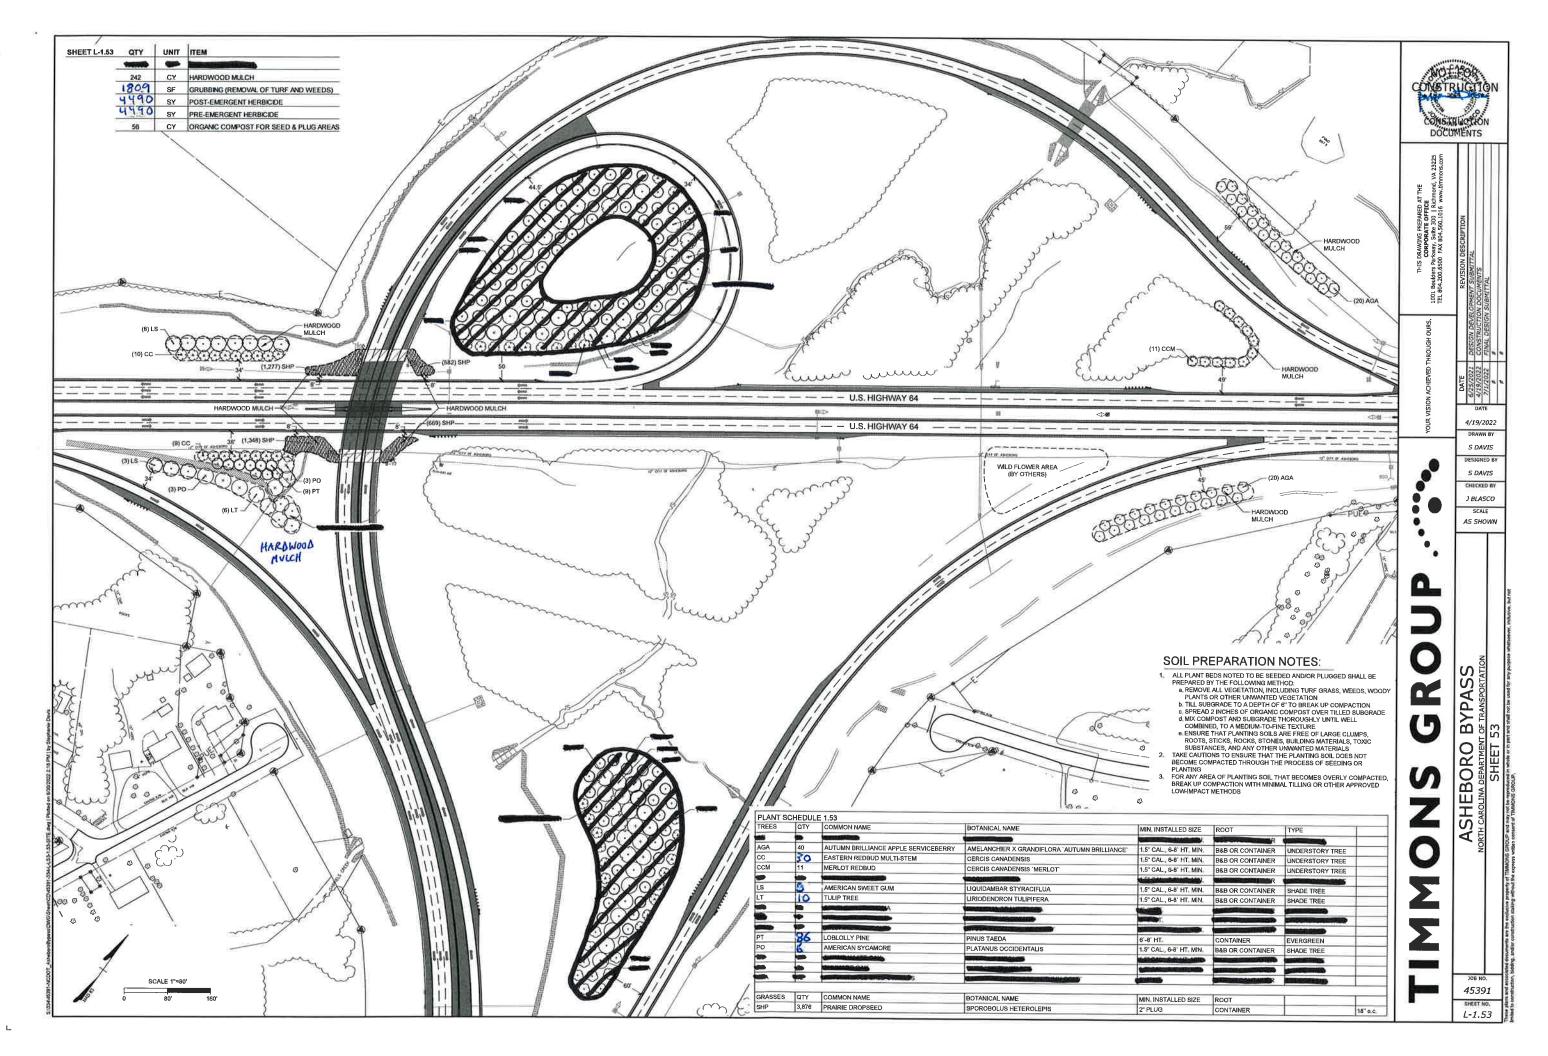

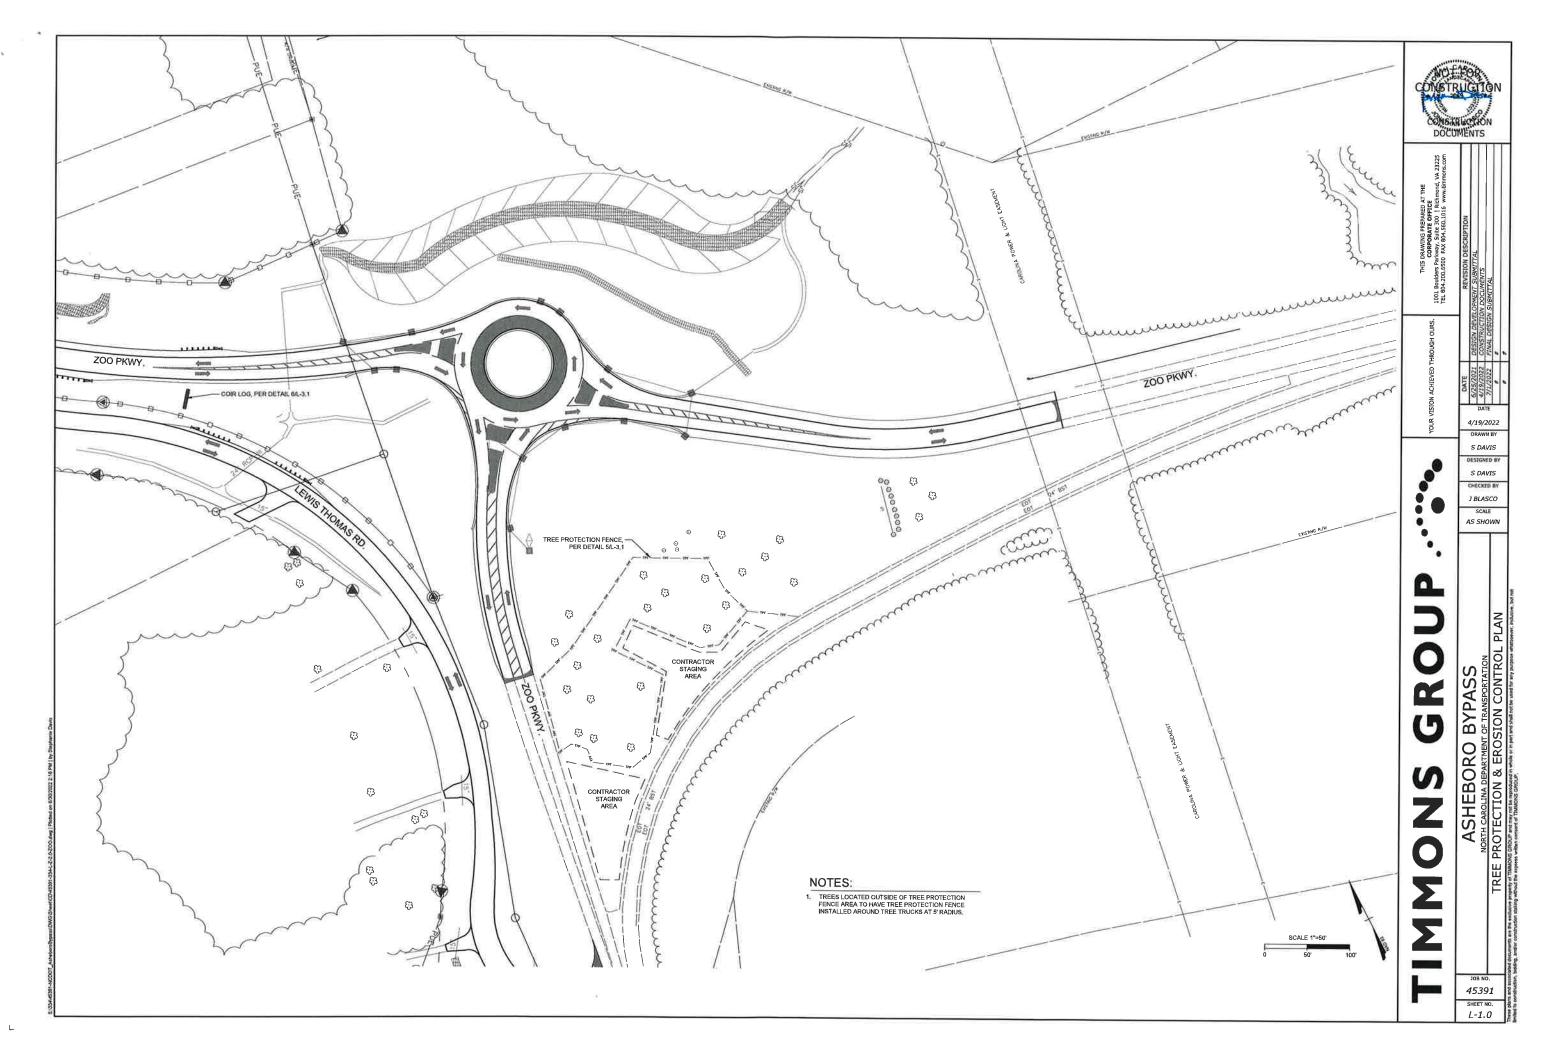

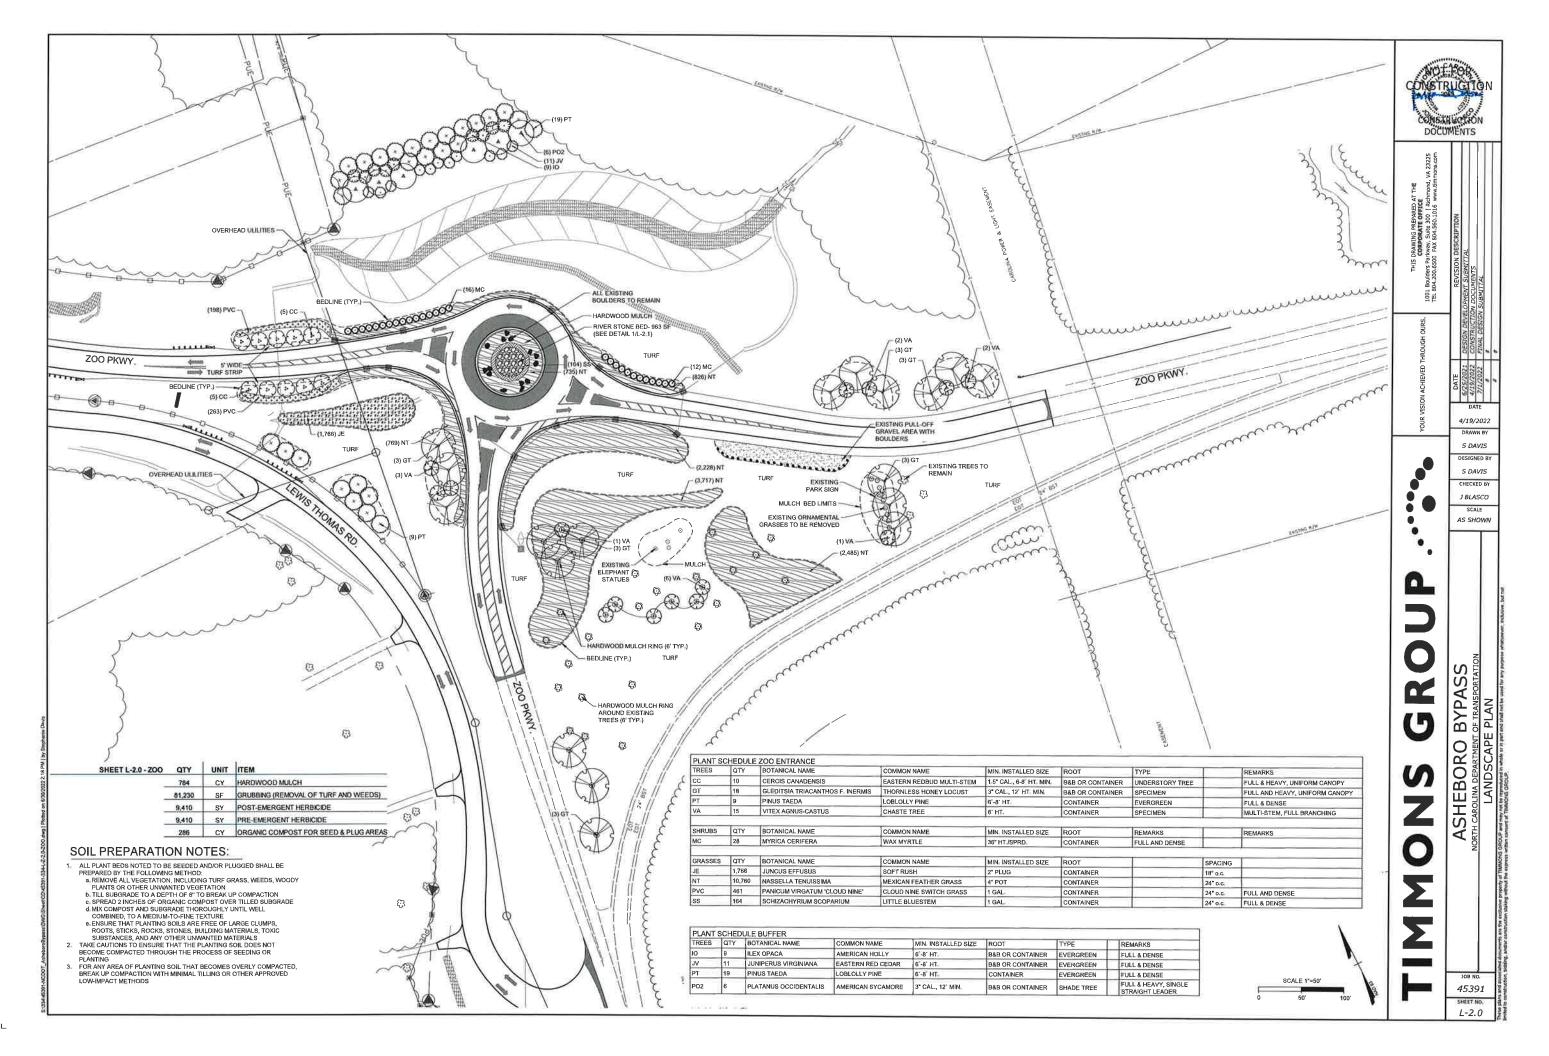

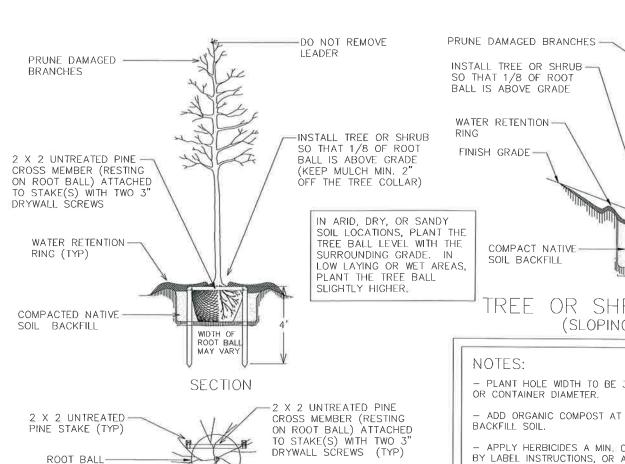

TREE PLANTING & ROOT BALL STAKING DETAIL (STAKE TREES 8' OR TALLER)

HEALTHY VASCULAR ROOT SYSTEM (NO ROOT SHAVING NEEDED)

ONCE ROOT BALL IS PLACED IN THE HOLE, FOLD BACK (OR REMOVE) TOP 1/3 OF FABRIC AND METAL CAGE.

ROOT BALL SHAVING CAN BE PERFORMED JUST PRIOR TO PLANTING OR AFTER PLACING IN THE HOLE.

BALL (MAX. 2") WITH SHARP SPADE SHOVEL(OR HAND SAW) TO REMOVE GIRDLING ROOTS.

TREE COLLAR

SHAVE OUTER PERIPHERY OF ROOT

TREE PLANTING INSTRUCTIONS (FOR CONTAINER OR BALLED & BURLAPPED TREES)

MULCH

TREE OR SHRUB PLANTING DETAIL (SLOPING GROUND)

- PLANT HOLE WIDTH TO BE 3 TIMES THE ROOT BALL SIZE
- ADD ORGANIC COMPOST AT 25-30% BY VOLUME TO
- APPLY HERBICIDES A MIN. OF 7 DAYS PRIOR TO PLANTING, BY LABEL INSTRUCTIONS, OR AS DIRECTED BY THE NCDOT
- APPLY FERTILIZER AT PLANTING TIME IN THE FORM OF A SLOW RELEASE PELLET OR TABLET. APPLY AT RATE RECOMMENDED BY MANUFACTURER, BOTH RATE AND FORMULATION MUST BE APPROVED BY FIELD ENGINEER PRIOR TO APPLICATION.
- ALL PRUNING TO FOLLOW STANDARD ARBORICULTURAL PRACTICES AS SPECIFIED BY INTERNATIONAL SOCIETY OF ARBORICULTURE.

GIRDLING & ROOT BOUND


ROOT SYSTEM (EXCESSIVE

ROOT GROWTH ENCIRCLING


ROOT BALL)

- DO NOT ATTEMPT TO STRAIGHTEN A TREE THAT HAS BEEN PLANTED AT AN ANGLE WITH THE USE OF STAKING OR GUYING. DIG TREE AND REPLANT TO UPRIGHT POSITION.


> -4' MIN. TO 8' MAX. NATURAL WEATHERED STONE TO BE PROVIDED BY NCDOT. STONE TO BE BURIED 1/3 IN GROUND AND 2/3 EXPÓSED.

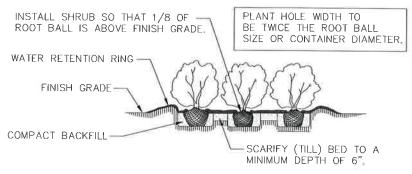

SHRUB BED PLANTING DETAIL

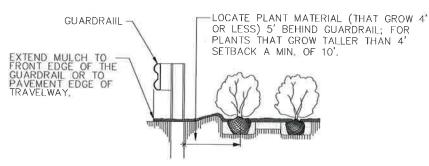

GUARDRAIL MULCHING DETAIL USE AS DIRECTED BY FIELD ENGINEER

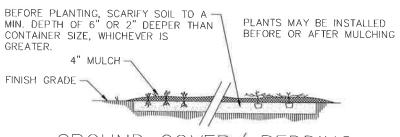

GROUND COVER/ BEDDING PLANT DETAIL



MIN. 12" DEEP CLASS "A" STONE ON FILTER FABRIC LINER IN DITCH. PLACE STONE FLUSH WITH DITCH GRADE FOR MAXINUM WATER FLOW.

CLASS "A" STONE DITCH LINING DETAIL



THIS DRAWING PREPARED AT THE CORPORATE OFFICE 1001 Boulders Parkway, Suite 300 | Richmond, TEL 804 200.6500 FAX 804.560,1016 www.bm

4/19/2022


S DAVIS DESIGNED BY S DAVIS CHECKED BY

J BLASCO AS SHOWN

a S BYPAS:

SHEBORO


45391 L-3.0

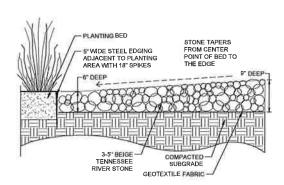

3-5" RIVER STONE BED

EVERGREEN PLANTING

(3)

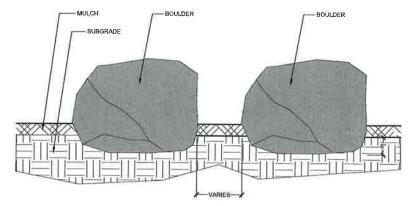

MIN, 10 GA. LINE WIRES


BOULDERS TO BE BURIED 6" (MIN) BELOW GRADE.


2. SPACE BOULDERS AS SHOWN ON SITE PLAN.

TREE PROTECTION

AREA DO NOT ENTER

BOULDERS 2

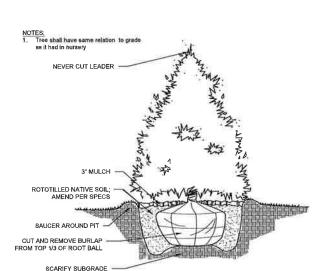

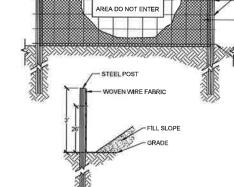

TREE PROTECTION

NOTES:

1. Do not disturb tree conservation areas,

2. Fencing life is 6-9 months,

3. Warning signs to be made of a durable weatherproof
material with minimum 3" high letters that are clearly
legible and spaced as detailed,

4. Maintain fence throughout fife of project,

5. Additional signs may be required based on field
conditions. Attach signs securely to fence posts and fabric Signs to be placed at each end of linear tree protection areas and 50° on center thereafter. No less than 1 sign per tree protection area.

FENCE FABRIC INSTALLED TO

SECOND WIRE FROM TOP

MIN, 10 GA. LINE WIRES

TREE PROTECTION FENCE

GENERAL PLANTING NOTES:

IDENTIFY ANY SUBSURFACE UTILITIES PRIOR TO COMMENCING WORK.
ALL PLANT MATERIALS TO COMPLY WITH AMERICAN STANDARD FOR NURSERY STOCK ANSI, 250.
SUBSTITUTIONS OF PLANT MATERIALS SPECIFIED CAN ONLY OCCUR WITH PRIOR APPROVAL BY LANDSCAPE ARCHITECT AND/OR ENGINEER.
CONTRACTOR TO PROTECT EXISTING BORNIANGE STRUCTURES THROUGHOUT CONSTRUCTION, ANY DAMAGE TO DRAINAGE STRUCTURES SHALL BE REPAIRED IN KIND BY
CONTRACTOR AT NO ADDITIONAL COST TO THE OWNER.
CONTRACTOR SHALL LOCATE ALL UTILITIES PRIOR TO CONSTRUCTION, ALL UTILITIES SHALL BE PROTECTED THROUGHOUT CONSTRUCTION AND ANY DAMAGE THAT MAY OCCUR
SHALL BE REPAIRED IN KIND BY THE CONTRACTOR WITH NO ADDITIONAL COST TO THE COMMER. CONTRACTOR SHALL LOCATE ALL UTILITIES PRIOR TO CONSTRUCTION, ALL UTILITIES SHALL BE PROTECTED THROUGHOUT CONSTRUCTION AND ANY DAMAGE THAT MAY OCCI SHALL BE REPAIRED IN NIDO BY THE CONTRACTOR WITH NO ADDITIONAL COST TO THE OWNER. NO PLANT SHALL BE INSTALLED CLOSER THAN 10' TO THE BACK OF GUARDRAIL, OR EDGE OF PAVEMENT IF NO GUARDRAIL IS PRESENT. INSTALL ALL PLANT MATERIALS AS DEFINED BY DETAILS AND SPECIFICATIONS. ALL TREES TO BE INSTALLED BEFORE MARCH 15 OR AFTER OCTOBER 15, ALL PLANTED AREAS, EXCEPT PINE TREE BEDS, TO BE MULCHED WITH 3" DOUBLE SHREDDED HARDWOOD MULCH AND PER SPECIFICATIONS, ALL PINE TREE BEDS SHALL BE MIS CHED WITH BINES TREAM MIS ICH.

9. ALL PLANTED AREAS, EXCEPT PINE TREE BEDS, TO BE MULCHED WITH 3" DOUBLE SHREDDED HARDWOOD MULCH AND PER SPECIFICATIONS, ALL PINE TREE BEDS SHALL BE MULCHED WITH PINE STRAW MULCH.

10. ALL TREES SHALL BE IN A UNIFORM BED OF MULCH WITH THE BED EDGE NO LESS THAN 3" FROM THE TRUNK OF THE TREE, KEEP MULCH 4" AWAY FROM TRUNK OF TREE.

11. TURR TO BE ______ UNLESS SPECIFIED OTHERMSE. SEED AND MULCH PER SPECS.

12. ALL PLANT BEDS TO BE PREPARED PER DETAIL 4.12.1 AND PER SPECS.

13. CONTRACTOR TO REPAIR ANY DAMAGED TURF AREAS DUE TO CONSTRUCTION ACTIVITIES.

14. CONTRACTOR TO REPAIR ANY DAMAGED TURF AREAS DUE TO CONSTRUCTION ACTIVITIES.

15. CONTRACTOR TO REPAIR ANY DAMAGED TURF AREAS DUE TO CONSTRUCTION ACTIVITIES.

16. CONTRACTOR TO WARRANTY PLANT MATERIALS FOR A TWO YEAR PERIOD FOLLOWING SUBSTANTIAL COMPLETION.

17. AREAS DAMAGED BY ACTIVITIES OF CONTRACTOR SHALL BE BE-ESTABLISHED TO PRE-DISTURBANCE CONDITION AT NO ADDITIONAL COST TO THE OWNER.

18. CONTRACTOR OF PLANTS AND PLANT BEDS TO BE FLAGGED BY CONTRACTOR AND VERHIED IN THE FIELD BY LANDSCAPE ARCHITECT, ENGINEER AND/OR OWNER PRIOR TO INSTALLATION.

20. CONTRACTOR TO IDENTIFY STAGING AREAS, LANDSCAPE ARCHITECT/ENGINEER AND/OR OWNER TO APPROVE LOCATIONS PRIOR TO CONSTRUCTION.

21. AREAS DISTURBED THAT ARE NOT NOTED FOR PLANT BEDS ARE TO BE SEEDED AND STRAWED PER SPECIFICATIONS.

22. PLANT MATERIAL NOT NOTED FOR REMOVAL, SHALL BE PROTECTED THROUGHOUT CONSTRUCTION.


23. USE HERBICIDES, PESTICIDES, AND FERTILIZER IN A MANNER CONSISTENT WITH THE FEDERAL INSECTICIDE, FUNGICIDE, AND RODENTICIDE ACT, NCDOT STANDARDS AND SPECIFICATIONS, NOT NOTED FOR REMOVAL, SHALL BE PROTECTED THROUGHOUT CONSTRUCTION.

24. ALL AREAS SITURBED THAT ARE NOT NOTED FOR PLANT BEDS ARE TO BE SEEDED AND STRAWED PER SPECIFICATIONS.

25. LANDSCAPE ARCHITECT AND/OR REMOVALS PROTECTED THROUGHOUT CONSTRUCTION.

26. LANDSCAPE ARCHITECT AND/OR REMOVALS PROTECTED THROUGHOUT CONSTRUCTION.

27. APPLY ALL TRAFFIC CONTROL MEASURES PER NODOT STANDARDS AND AS DIRECTED BY NODOT FREES WITH DAMAGED OR DEFORM

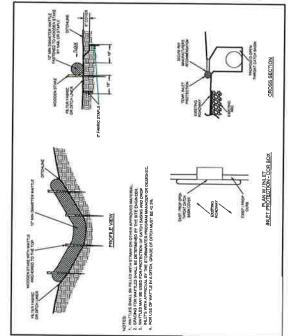





1001 Boulders Parks TEL 804, 200,6500

4/19/2022 S DAVIS

DESIGNED BY S DAVIS CHECKED BY J BLASCO

SCALE AS SHOWN

S

BYPA SHEBORO

d

45391

. .

L-3.1